

THIS IS TO CERTIFY THAT ON ______ I RECEIVED FROM THE GROVELAND PLANNING BOARD CERTICATION OF TIS APPROVAL OF THIS PLAN AND THAT DURING THE TWENTY (20) DAYS NEXT FOLLWOGIN I HAVE RECEIVED NO NOTICE OF ANY APPEAL FROM SAID DECISION.

CLERK DATE

APPROVED UNDER SUBDIVISION CONTROL LAW M.G.L. CHAPT. 141 SEC. 81U

DATE:

APPROVED BY:

GROVELAND PLANNING BOARD.



DEFINITIVE SUBDIVISION
FOR A
STREET TO BE NAMED
GROVELAND, MASSACHUSETTS

181R SCHOOL STREET

(GROVELAND ASSESSOR'S MAP 34 LOT 13)
PREPARED FOR/APPLICANT:

GROVELAND REDEVELOPMENT, LLC
231 SUTTON STREET, SUITE 1B

NORTH ANDOVER, MA 01845

OWNER:

181R SCHOOL STREET, LLC
5 ATKINSON FARM ROAD
ATKINSON, NH 03811

JULY 31, 2024

Morin-Cameron

GROUP, INC.


CIVIL ENGINEERS LENVIRONMENTAL CONSULTANTS
LAND SURVEYORS LAND USE PLANNERS
25 KENOZA AVENUE, MASSACHUSETTS 01830
P: 978-373-0310, W: WWW.MORINCAMERON.COM

REVISIONS
DESCRIPTION DATE
COVER
SHEET

ER DRAWING NO C-1

DRAWING: 3634 MAIN.dwg

MAP 25, LOT 12 CONDOMINIUM WHITESTONE VILLAGE CONDOMINIUM 701 ALYSSA DR SCS SOIL LEGEND: GROVELAND, MA 01834 CONC. BLOCK RET. WALL 410C SUTTON FINE SANDY LOAM, 8 TO 15% SLOPES 420B CANTON FINE SANDY LOAM, 3 TO 8% SLOPES 420C CANTON FINE SANDY LOAM, 8 TO 15% SLOPES 421C CANTON FINE SANDY LOAM, 8 TO 15% SLOPES MAP 34, LOT 10 WHITESTONE VILLAGE CONDOMINIUM FOR REGISTRY USE ONLY 305 DIANNE CR GROVELAND, MA 01834 HEREBY CERTIFY THAT THIS PLAN HAS BEEN PREPARED IN CONFORMANCE WITH THE RULES AND REGULATIONS OF THE REGISTERS OF DEEDS OF THE COMMONWEALTH OF MASSACHUSETTS. AREA=245,945± S.F GARY RHODES $AREA=5.65\pm AC.$ 8 ANNE ST MAP 34, LOT 13 GROVELAND, MA 181R SCHOOL STREET, LLC 5 ATKINSON FARM RD ATKINSON, NH 03811 DEED BOOK 35976 PAGE 77 ASSESSORS MAP 34 LOT 13 410C **GENERAL NOTES:** THIS PLAN IS PREPARED FOR OUR CLIENTS USE ONLY FOR THE SPECIFIC PURPOSE OF DEPICTING EXISTING CONDITIONS OBTAINED BY AN ON-THE-GROUND FIELD SURVEY BY THE MORIN-CAMERON GROUP IN MARCH 2019. 2. ABUTTER INFORMATION SHOW HEREON WAS TAKEN FROM THE GROVELAND GIS DATABASE. FLOOD NOTE:
THE SUBJECT PROPERTY IS LOCATED ENTIRELY WITHIN A ZONE X: AREA OF MINIMAL FLOOD MAP 34, LOT 16 HAZARD ABOVE THE 500-YEAR FLOOD LEVEL AS ILLUSTRATED ON THE FLOOD INSURANCE JEFFERY MANISCALCO RATE MAP COMMUNITY PANEL NO. 25009C0232F, WHICH HAS AN EFFECTIVE DATE OF JULY 6 ANNE ST GROVELAND, MA 01834 ELEVATIONS HEREON REFER TO NAVD88 VERTICAL DATUM AND MassSPC NAD 1983 ALL UNDERGROUND UTILITIES SHOWN ARE APPROXIMATE ONLY AND ARE BASED ON LOCATIONS OF OBSERVABLE FIELD EVIDENCE AND RECORDS OBTAINED FROM VARIOUS GROVELAND MUNICIPAL DEPARTMENTS. ACTUAL LOCATIONS MUST BE DETERMINED IN THE FIELD. BEFORE DESIGNING, EXCAVATING, BLASTING, INSTALLING, BACKFILLING, GRADING, PAVEMENT RESTORATION, REPAVING OR OTHER CONSTRUCTION, ALL UTILITY COMPANIES MUST BE NOTIFIED INCLUDING THOSE IN CONTROL OF UTILITIES NOT SHOWN ON THIS PLAN. SEE CHAPTER 370, ACTS OF 1963, MASSACHUSETTS. CALL MAP 34, LOT 15 STEVEN MASSERO "DIG SAFE" AT 1-888-344-7233. THE MORIN-CAMERON GROUP, INC. ASSUMES NO RESPONSIBILITY 4 ANNE ST FOR DAMAGES INCURRED AS A RESULT OF UTILITIES OMITTED OR INACCURATELY SHOWN. BEFORE GROVELAND, MA 01834 FUTURE CONNECTIONS, THE APPROPRIATE UTILITY ENGINEERING DEPARTMENTS MUST BE CONSULTED. **ZONING NOTE:** THE LOT LIES WITHIN THE RESIDENTIAL DISTRICT (R-2) & AQUIFER PROTECTION DISTRICT (ZONE III). RESIDENCE DISTRICT R-2 ZONING DISTRICT yearing SETBACK REQUIRED **EXISTING** 420B 30,000 S.F. (1) 245,945± S.F. MIN. AREA MIN. FRONTAGE 150 FT. (1) 180.26± FT #102 SEE LOTTING PLAN (SHEET C-3) FOR METES AND BOUNDS-FRONT 30 FT. (3) N/A 15 FT. (2) SIDE N/A REAR 15 FT. N/A MAP 34, LOT 14 HOMES OF CARE III, INC MAX. BUILDING HEIGHT 35 FT. N/A 102 GLENN ST MAP 34, LOT 10A LAWRENCE, MA 01843 HILEMAN REALTY TRUST MAX. % LOT COVERAGE 25% 0% 185 SCHOOL ST GROVELAND, MA 01834 MAX. % IMPERVIOUS AREA 50% 0% MAP 34, LOT 12 DERRICK M. DEVEAU % OF MIN. REQUIRED LOT 24-2 181 SCHOOL ST AREA AS CONTIGUOUS 60% (4) 100% GROVELAND, MA 01834 BUILDABLE AREA SIDEWALK 1) TWO-FAMILY OR DUPLEX STRUCTURES REQUIRE A MIN. OF TWO HUNDRED (200) FEET OF FRONTAGE AND 40,000 SF AREA IN THE R-2 DISTRICT. - GUY WIRE (TYP.) $RIM = 98.1 \pm$ (2) ON A LOT WITH LESS THAN ON HUNDRED FIFTY (150) FEET OF FRONTAGE AND IN EXISTENCE AT THE TIME THIS BY-LAW IS PASSED, NO BUILDING SHALL BE ERECTED WITHIN TEN (10) FEET OF A SIDE APPROX. SEWER STUB #185 APPROX. WATER SERVICE STUB-RIM=98.7± - BIT. CONC. (3) IN ANY RESIDENTIAL DISTRICT NO BUILDING OR ROADSIDE STAND SHALL BE ERECTED OR PLACED APPROX. SEWER STUB-WITHIN THIRTY (30) FEET OF A STREET LINE UNLESS IT IS DETERMINED THAT THE LINE OF HOUSES ACCESSIBLE RAMP EXISTING AT THE TIME THIS BY-LAW IS ADOPTED IS LESS THAN THIRTY (30) FEET FROM THE STREET 24-1 BIT. CONC. LINE, AND NO BUILDING OR ACCESSORY USE OR FARM OR POULTRY FARM BUILDING OTHER THAN A DRIVE DWELLING. OR ROADSIDE STAND. OR PRIVATE GARAGE, SHALL BE BUILT WITHIN SIXTY (60) FEET OF A STREET LINE. CONC. SIDEWALK / RIM=106.6± CROSSWALK _____S INV=98.2± (4) FIFTY (50) PERCENT IF PARCEL IS SERVICED BY TOWN WATER AND SEWER. 8" AC S=0.010 FT/FT S=0.019 FT/FT SCHSOOL CONTIGUOUS BUILDABLE AREA:
THAT AREA OF A LOT THAT IS CONTIGUOUS AND BUILDABLE LAND AS REQUIRED BY SECTION 8.1 APPROX. 4" 12" WATER MAIN GAS MAIN SIDEWALK RIM=106.7± TABLE OF DIMENSIONAL REQUIREMENTS, TOGETHER WITH THAT AREA WITHIN REQUIRED SETBACKS TO CONC. DRIVE THE EXTENT SUCH AREA COMPLIES WITH THE FURTHER REQUIREMENTS OF THIS DEFINITION. WETLANDS DESCRIBED BY G.L. C. 131, INCLUDING ANY NO DISTURBANCE AND NO BUILD SETBACK AREAS IN E E ACCORDANCE WITH G.L. C. 131, AND THE TOWN OF GROVELAND WETLANDS BY-LAW AND ACCOMPANYING REGULATIONS, AND SLOPES IN EXCESS OF TWENTY (20) PERCENT SHALL NOT BE $RIM = 103.9 \pm$ RIM=103.8± MA CB SMH RIM=97.6± - APPROX. TELEPHONE CONSIDERED AS BUILDABLE FOR THE PURPOSE OF CALCULATING SQUARE FOOTAGE. RIM=98.1± 20 MAP 34, LOT 20 - ACCESSIBLE RIM=104.3± SCOTT BERUBE INV=89.0± AW MAP 25, LOT 148 GEORGE R. PROVENCAL 186 SCHOOL ST MAP 25, LOT 149 SECTION 50-8.2.A: NO LOT SHALL BE CREATED SO AS TO BE SO IRREGULARLY SHAPED OR MAP 34, LOT 26 GROVELAND ASON E. GORE EXTENDED THAT IT HAS A "SHAPE FACTOR" IN EXCESS OF (32), EXCEPT THAT A LOT MAY EXCEED BRUCE R. BEDARD 182 SCHOOL ST MA 01834 184 SCHOOL ST MAP 34, LOT 21 MAP 34, LOT 25 192 SCHOOL ST GROVELAND, MA 01834 THE REQUIRED "SHAPE FACTOR" IF A CONTIGUOUS PORTION OF THE LOT MEETS THE MINIMUM LOT KEITH C. KOWALICK GROVELAND, MA 01834 ALFRED A. SCOTT, JR. GROVELAND, MA 01834 AREA REQUIREMENT AND DOES NOT EXCEED THE REQUIRED "SHAPE FACTOR." THE SHAPE FACTOR 190 SCHOOL ST GROVELAND, MA 01834 SCALE: 1" = 40'EQUALS THE SQUARE OF THE LOT PERIMETER DIVIDED BY THE LOT AREA. SHAPE FACTOR = $(LOT PERIMETER)^2/LOT AREA$ DRAWING: 3634 MAIN.dwg

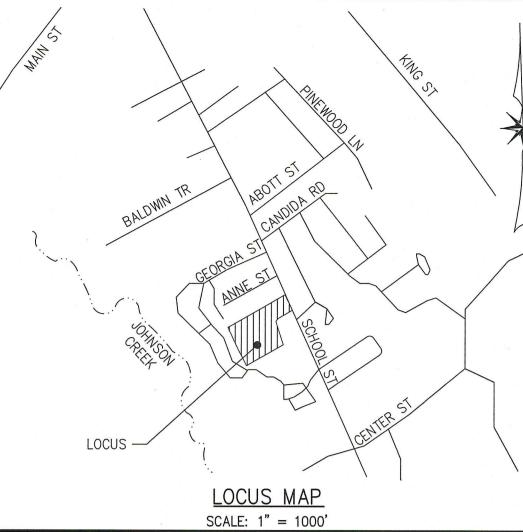

TOWN OF GROVELAND OFFICE OF THE TOWN CLERK

THIS IS TO CERTIFY THAT ON ______ I RECEIVED FROM THE GROVELAND PLANNING BOARD CERTICATION OF TIS APPROVAL OF THIS PLAN AND THAT DURING THE TWENTY (20) DAYS NEXT FOLLWOGIN I HAVE RECEIVED NO NOTICE OF ANY APPEAL FROM SAID DECISION.

DATE

APPROVED UNDER SUBDIVISION CONTROL LAW M.G.L. CHAPT. 141 SEC. 81U

APPROVED BY:

SUBJECT TO TERMS AND CONDITIONS STATED IN A MEMORANDUM OF DECISION DATED _____, _____BETWEEN THE

GROVELAND PLANNING BOARD, ON BEHALF OF THE TOWN OF GROVELAND, ___. A COPY OF WHICH DECISION IS RECORDED HEREWITH AND SUBJECT ALSO TO RECORDING OF THIS PLAN AND SAID DECISION IN THE SOUTH ESSEX REGISTRY OF

CONDITIONS OF A COVENANT DATED _____, ____

GROVELAND PLANNING BOARD.



DEFINITIVE SUBDIVISION FOR A

STREET TO BE NAMED

GROVELAND, MASSACHUSETTS

181R SCHOOL STREET

(GROVELAND ASSESSOR'S MAP 34 LOT 13)

PREPARED FOR/APPLICANT: GROVELAND REDEVELOPMENT, LLC

231 SUTTON STREET, SUITE 1B NORTH ANDOVER, MA 01845 OWNER:

181R SCHOOL STREET, LLC

5 ATKINSON FARM ROAD ATKINSON, NH 03811 JULY 31, 2024

Morin-Cameron

REVISIONS

DESCRIPTION

GROUP, INC. CIVIL ENGINEERS | ENVIRONMENTAL CONSULTANTS

LAND SURVEYORS I LAND USE PLANNERS 25 KENOZA AVENUE, MASSACHUSETTS 01830 P: 978-373-0310, W: WWW.MORINCAMERON.COM

> **EXISTING** DATE

DRAWING NO CONDITIONS

FOR REGISTRY USE ONLY HEREBY CERTIFY THAT THIS PLAN HAS BEEN PREPARED IN CONFORMANCE WITH THE RULES AND REGULATIONS OF THE REGISTERS OF DEEDS OF THE COMMONWEALTH OF MASSACHUSETTS.

ASSESSOR REFERENCE:

MAP 34 LOT 13

NOTES:

ORIENTATION IS TO NAD83 MASSACHUSETTS STATE PLANE COORDINATES.

KEY REFERENCE DEED:


DEED FROM FRANK J. FRANZONE TO 181R SCHOOL STREET, LLC. DATED JUNE 23 2017 AND RECORDED AT THE SOUTH ESSEX REGISTRY OF DEEDS BOOK 35976 PAGE 77.


KEY REFERENCE PLANS:

- 1. A PLAN OF A PORTION OF SCHOOL, GARDNER AND ELM PARK STREETS FROM SALEM STREET TO MAIN STREET IN THE TOWN OF GROVELAND AS RELOCATED. DRAWN BY F. RICHARD GELOTTI, SENIOR ASSISTANT COUNTY ENGINEER. DATED DEC. 18, 1984, E.C.L.O. No. 3203 AND RECORDED IN THE SOUTH ESSEX REGISTRY OF DEEDS.
- 2. PLAN OF LAND AT 171 SCHOOL STREET IN GROVELAND, MASSACHUSETTS BY ATLANTIC ENGINEERING & SURVEY CONSULTANTS INC. DATED MARCH 2, 2010 AND RECORDED IN THE SOUTH ESSEX REGISTRY OF DEEDS PLAN BOOK 423 PLAN 27.
- 3. PLAN OF LAND IN GROVELAND, MASS. OCCUPIED BY CHARLES A. & NORMA J. MCGLEW BY PHILLIP A. BEVELAQUA. RLS DATED OCT. 25, 1965 AND RECORDED IN THE SOUTH ESSEX REGISTRY OF DEEDS PLAN 667 OF 1965.
- 4. PLAN OF LAND FOR WHITESTONE VILLAGE II AT SCHOOL STREET IN GROVELAND, MASSACHUSETTS BY ATLANTIC ENGINEERING & SURVEY CONSULTANTS INC. DATED OCT. 21, 2004 AND RECORDED IN THE SOUTH ESSEX REGISTRY OF DEEDS PLAN BOOK 381 PLAN 79.
- 5. PLAN OF LAND IN GROVELAND, MASS. AS SURVEYED FOR RAY B. DREW. BY ROBERT G. GOODWIN, RLS. DATED MAY 2, 1983 AND RECORDED IN THE SOUTH ESSEX REGISTRY OF DEEDS PLAN BOOK 178 PLAN 67.
- 6. PLAN OF LAND IN GROVELAND, MASS. AS SURVEYED FOR DAVID DALE CORP. BY CHARLES H. MORSE & SON, ENGINEERS. DATED JULY 1968 AND RECORDED IN THE SOUTH ESSEX REGISTRY OF DEEDS PLAN 301 OF 1968.



(NOT TO SCALE)

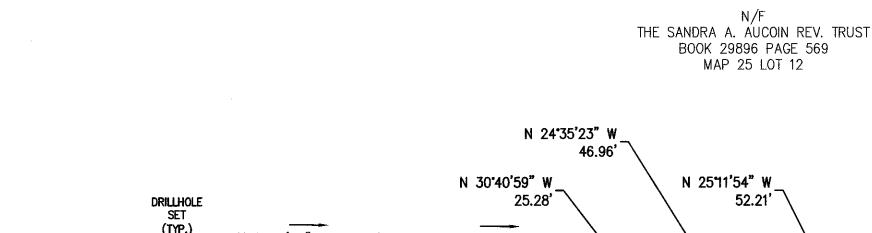

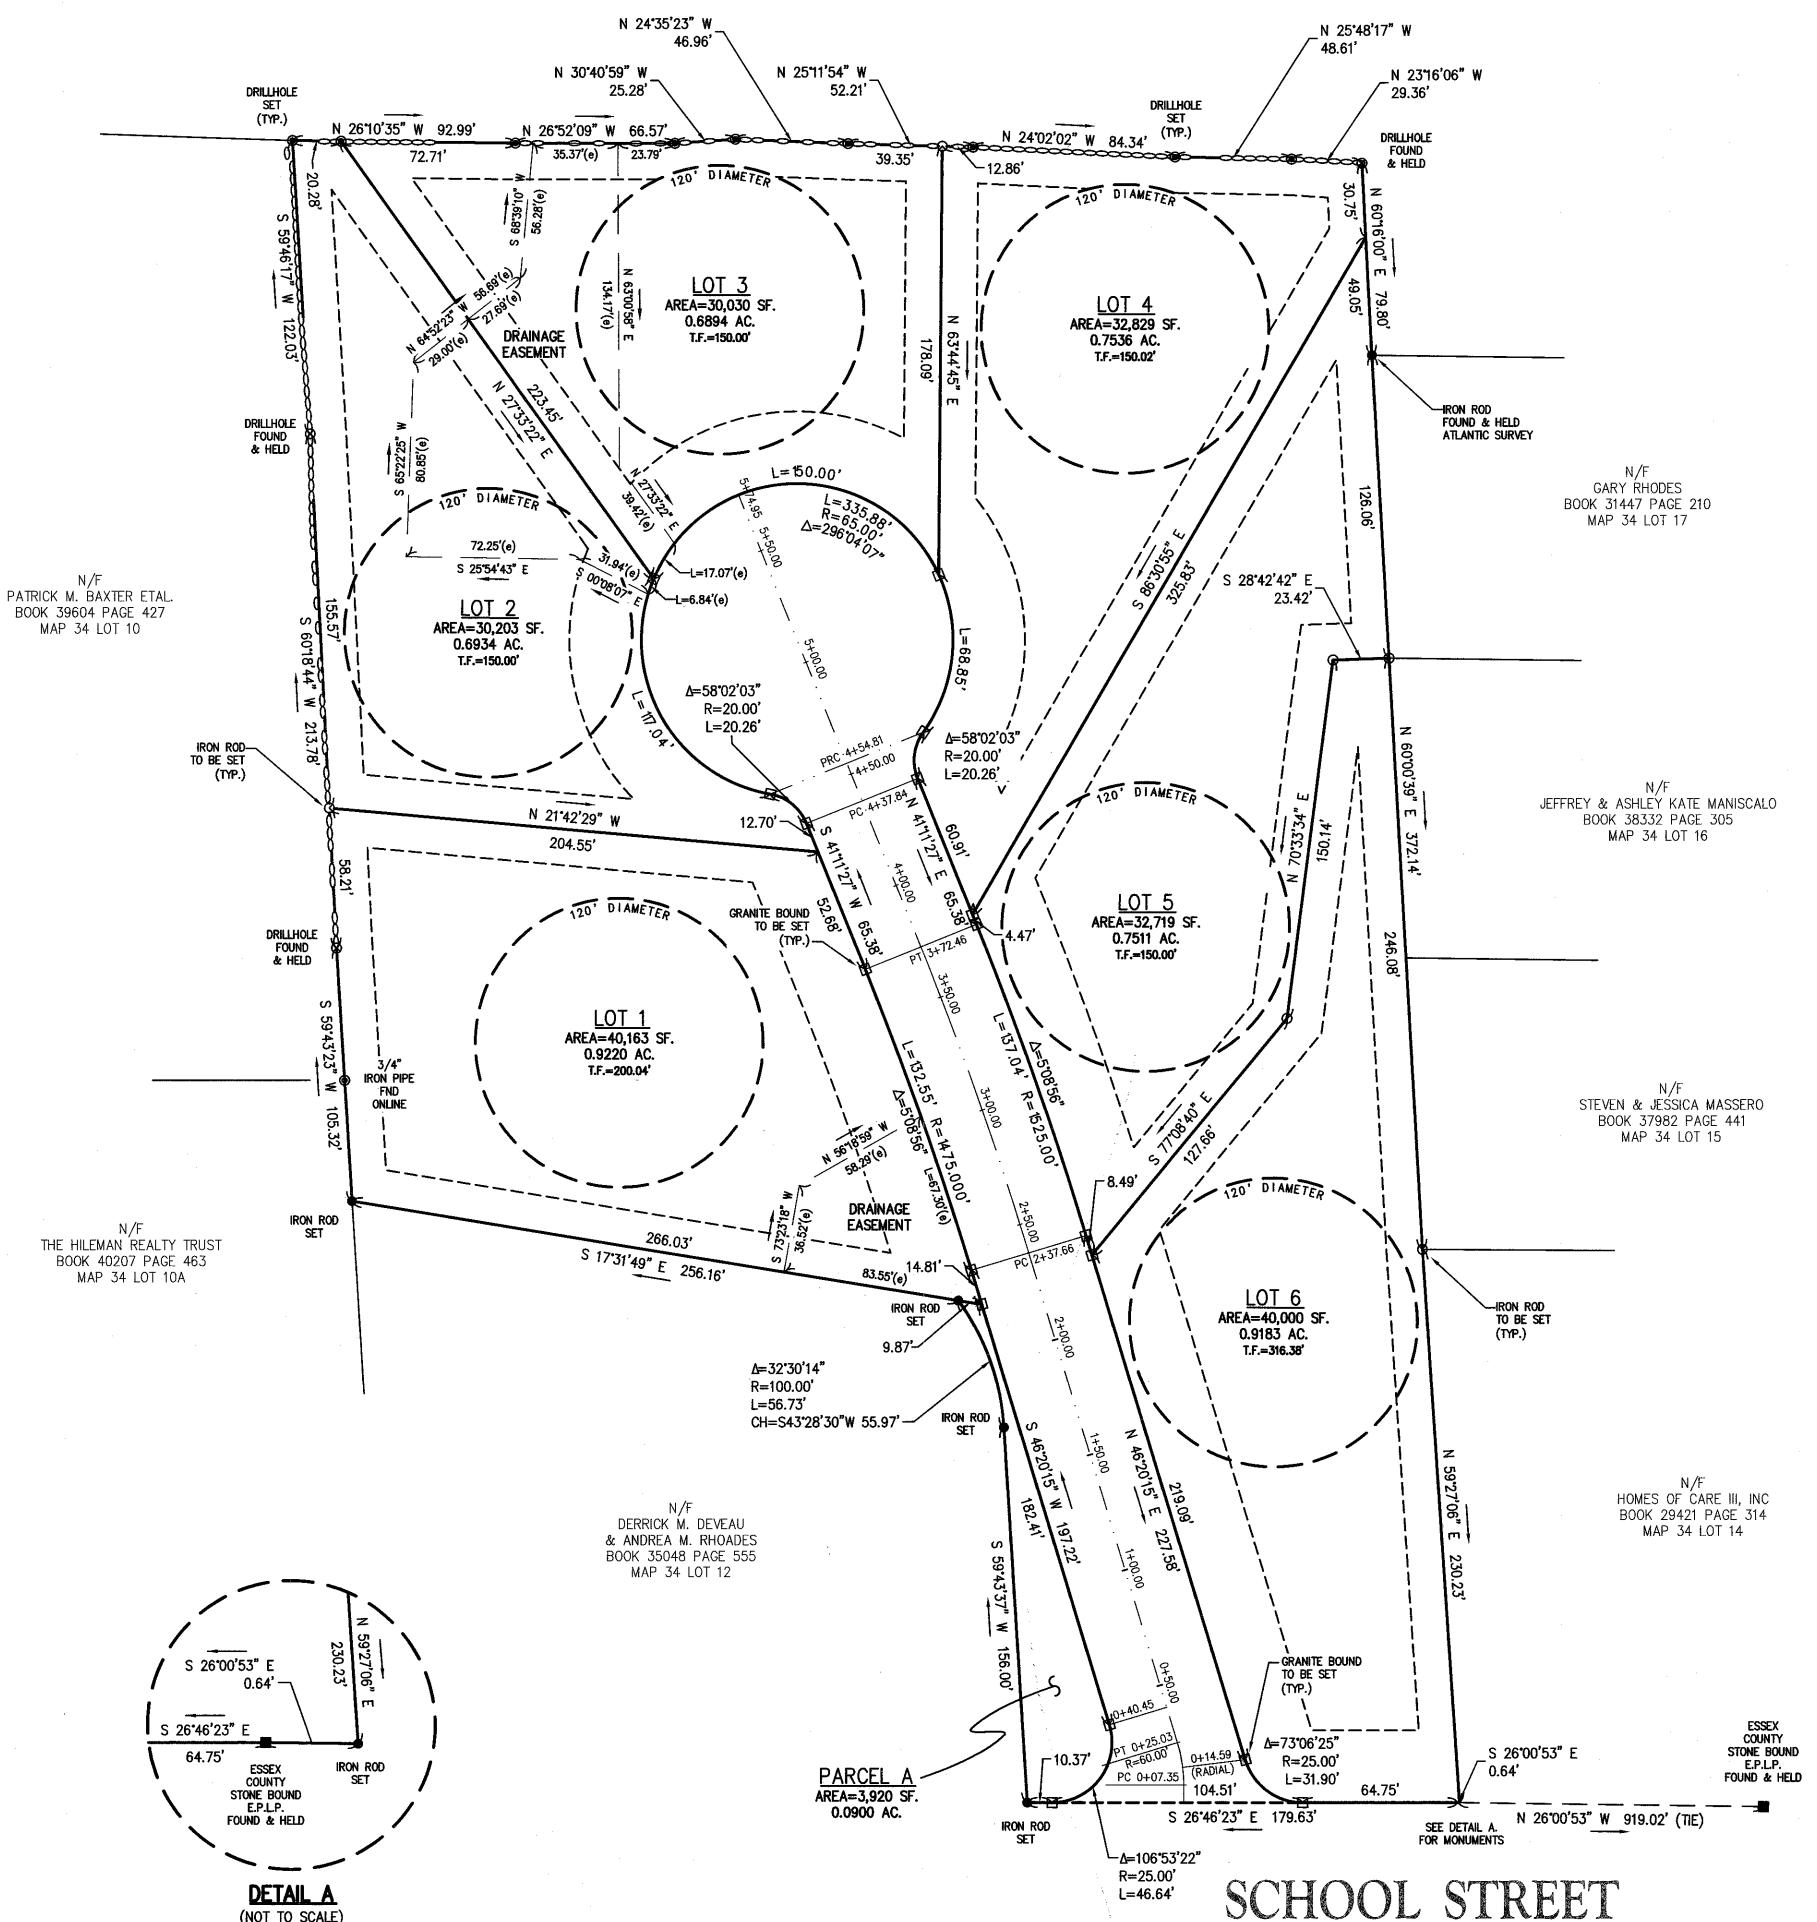

(PUBLIC \sim 50' WIDE \sim E.C.L.O. 3203)

LOT REGULARITY CALCULATIONS				
LOT#	PERIMETER (L.F.)	AREA (S.F.)	P²/A	STATUS
1	834	40,163	17	PASS
2	876	30,203	25	PASS
3	802	30,030	21	PASS
4	860	32,829	22	PASS
5	952	32,719	28	PASS
6	1,094	40,000	30	PASS

*PARCEL A IS NOT A BUILDABLE LOT

TOWN OF GROVELAND OFFICE OF THE TOWN CLERK

THIS IS TO CERTIFY THAT ON _____ ____ I RECEIVED FROM THE GROVELAND PLANNING BOARD CERTICATION OF TIS APPROVAL OF THIS PLAN AND THAT DURING THE TWENTY (20) DAYS NEXT FOLLWOGIN I HAVE RECEIVED NO NOTICE OF ANY APPEAL FROM SAID DECISION.

DATE APPROVED UNDER SUBDIVISION CONTROL LAW M.G.L. CHAPT. 141 SEC. 81U APPROVED BY:

APPROVED _____, ____ SUBJECT TO TERMS AND CONDITIONS STATED IN A MEMORANDUM OF DECISION DATED ______, _____

GROVELAND PLANNING BOARD, ON BEHALF OF THE TOWN OF GROVELAND, _____ A COPY OF WHICH DECISION IS RECORDED HEREWITH AND SUBJECT ALSO TO RECORDING OF THIS PLAN AND SAID DECISION IN THE SOUTH ESSEX REGISTRY OF DEED ON OR BEFORE ______, _____. SUBJECT TO TERMS AND CONDITIONS OF A COVENANT DATED ______, ____

GROVELAND PLANNING BOARD.



DEFINITIVE SUBDIVISION FOR A

STREET TO BE NAMED

GROVELAND, MASSACHUSETTS

181R SCHOOL STREET

(GROVELAND ASSESSOR'S MAP 34 LOT 13) PREPARED FOR/APPLICANT:

GROVELAND REDEVELOPMENT, LLC

231 SUTTON STREET, SUITE 1B

NORTH ANDOVER, MA 01845 OWNER:

181R SCHOOL STREET, LLC

5 ATKINSON FARM ROAD ATKINSON, NH 03811 JULY, 2024


Morin-Cameron


GROUP, INC.


CIVIL ENGINEERS | ENVIRONMENTAL CONSULTANTS
LAND SURVEYORS | LAND USE PLANNERS
25 KENOZA AVENUE, MASSACHUSETTS 01830 P: 978-373-0310, W: WWW.MORINCAMERON.COM


REVISIONS DATE DESCRIPTION


DRAWING NO

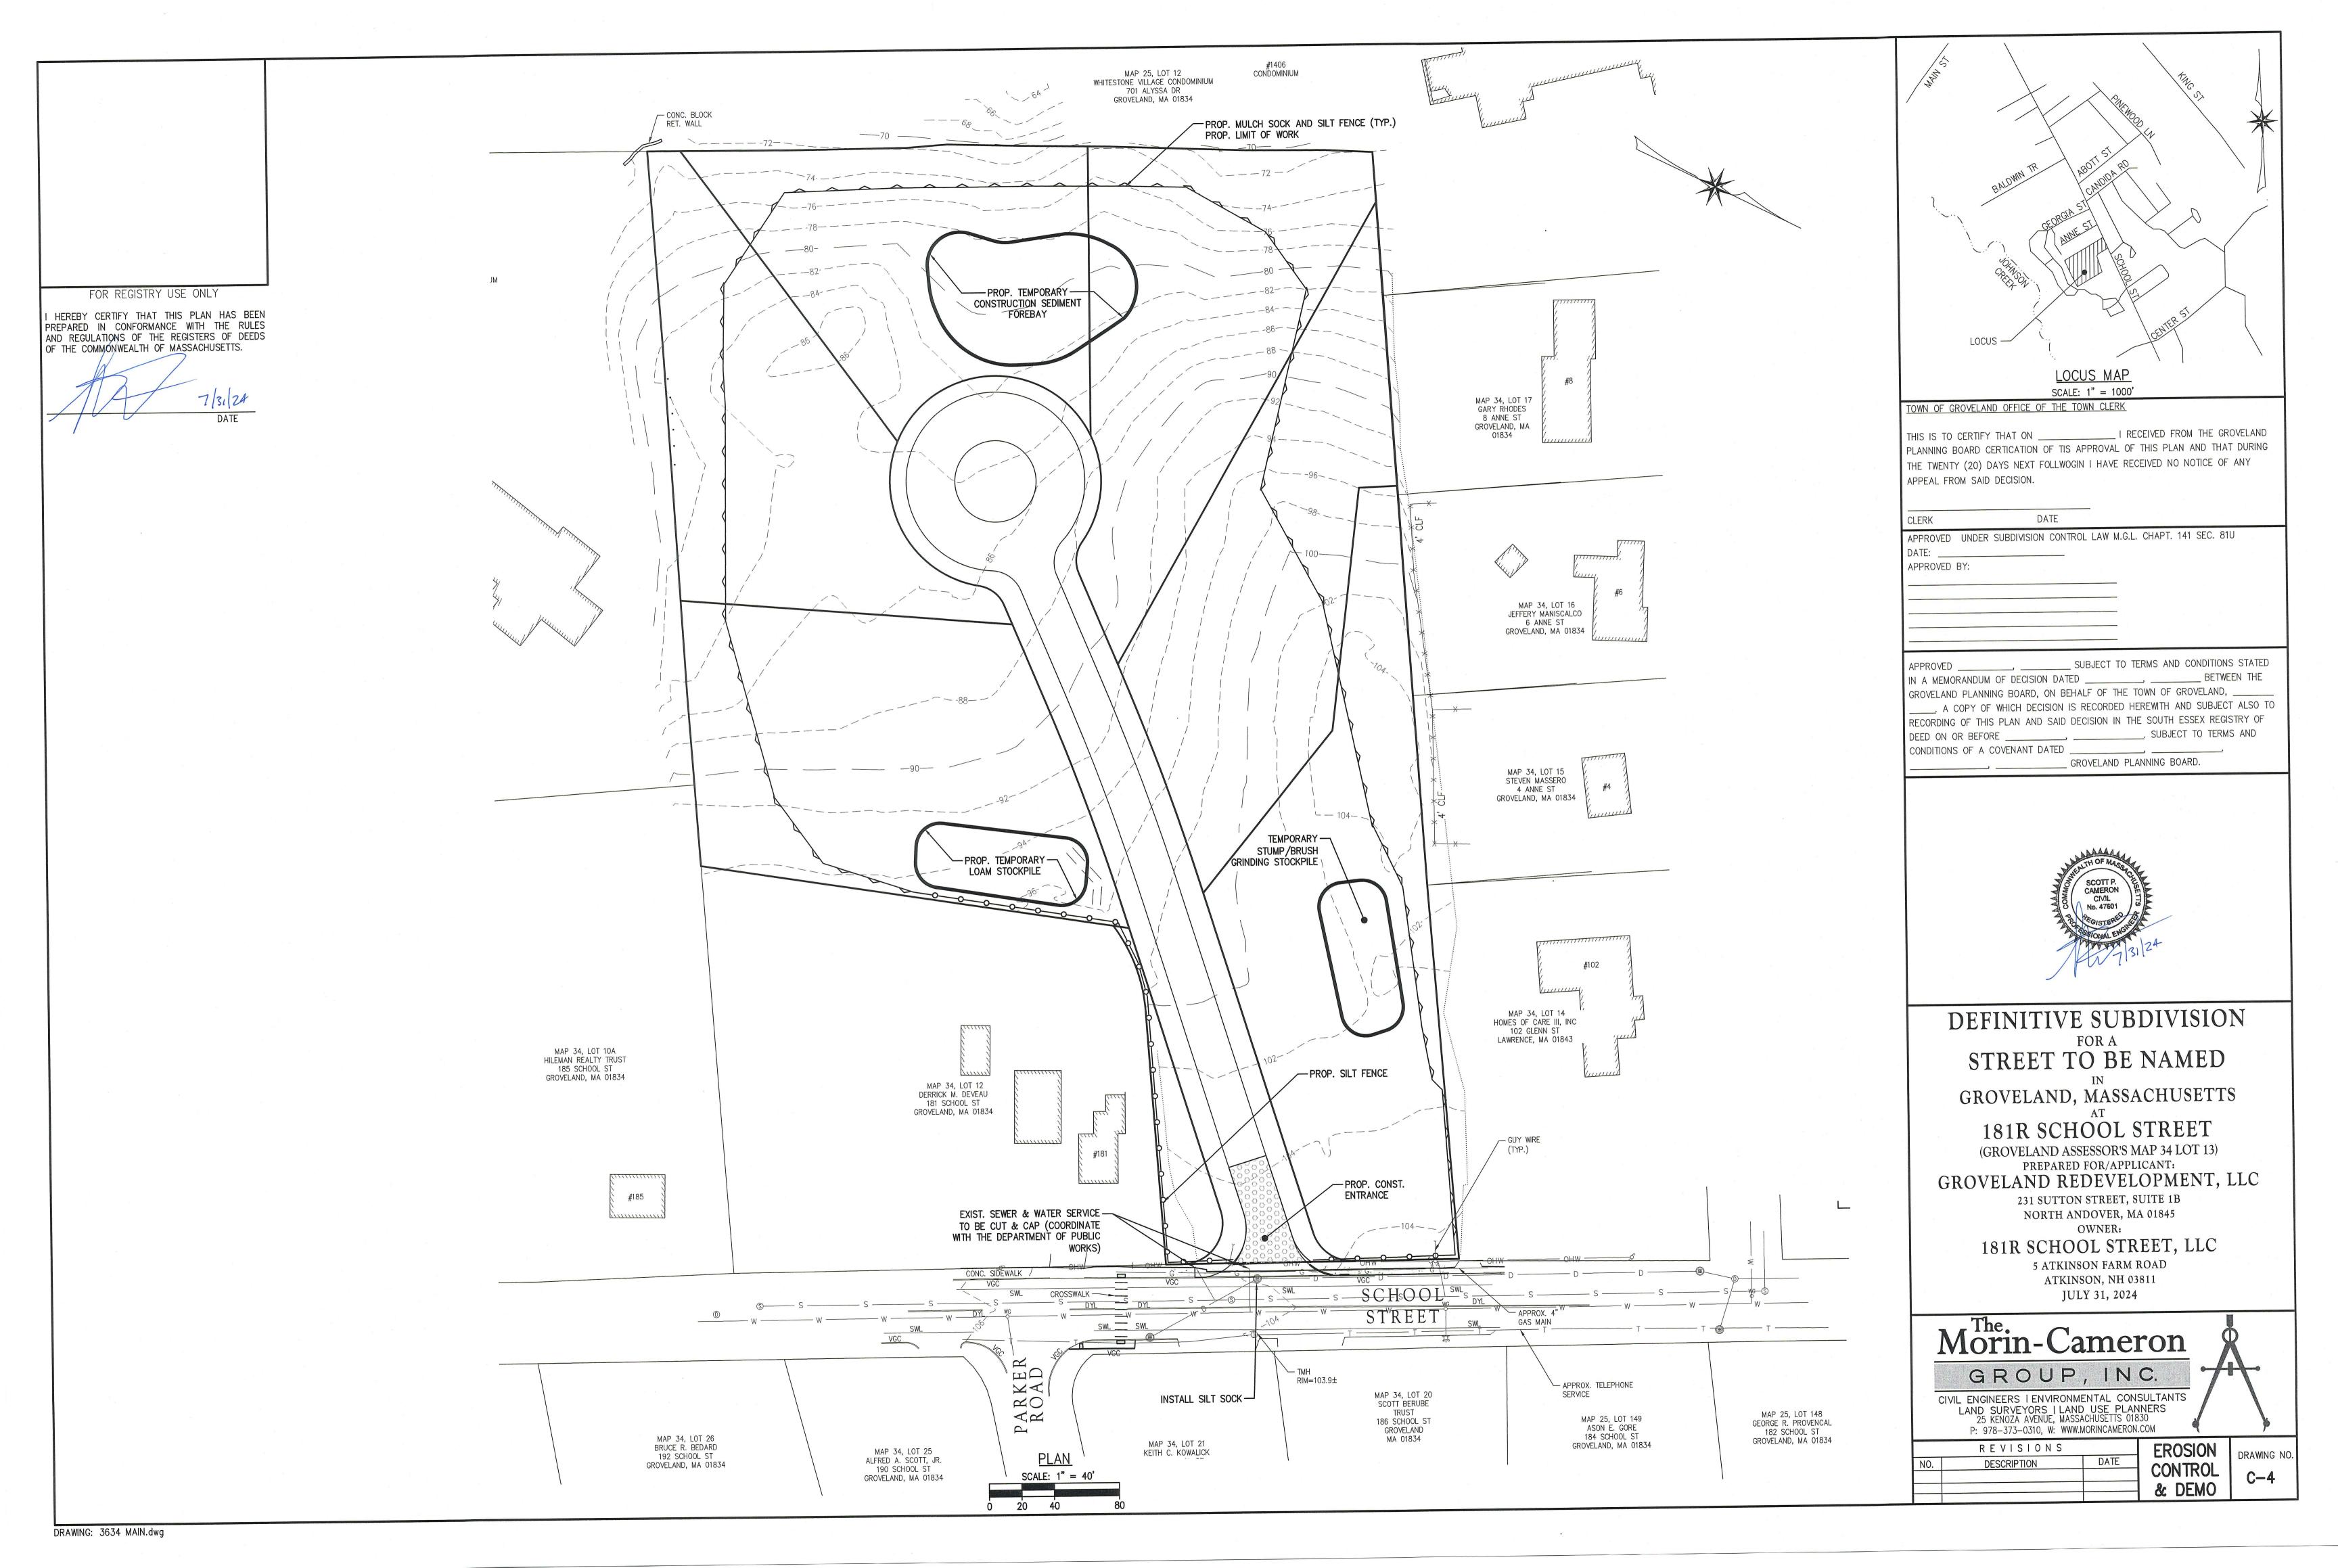


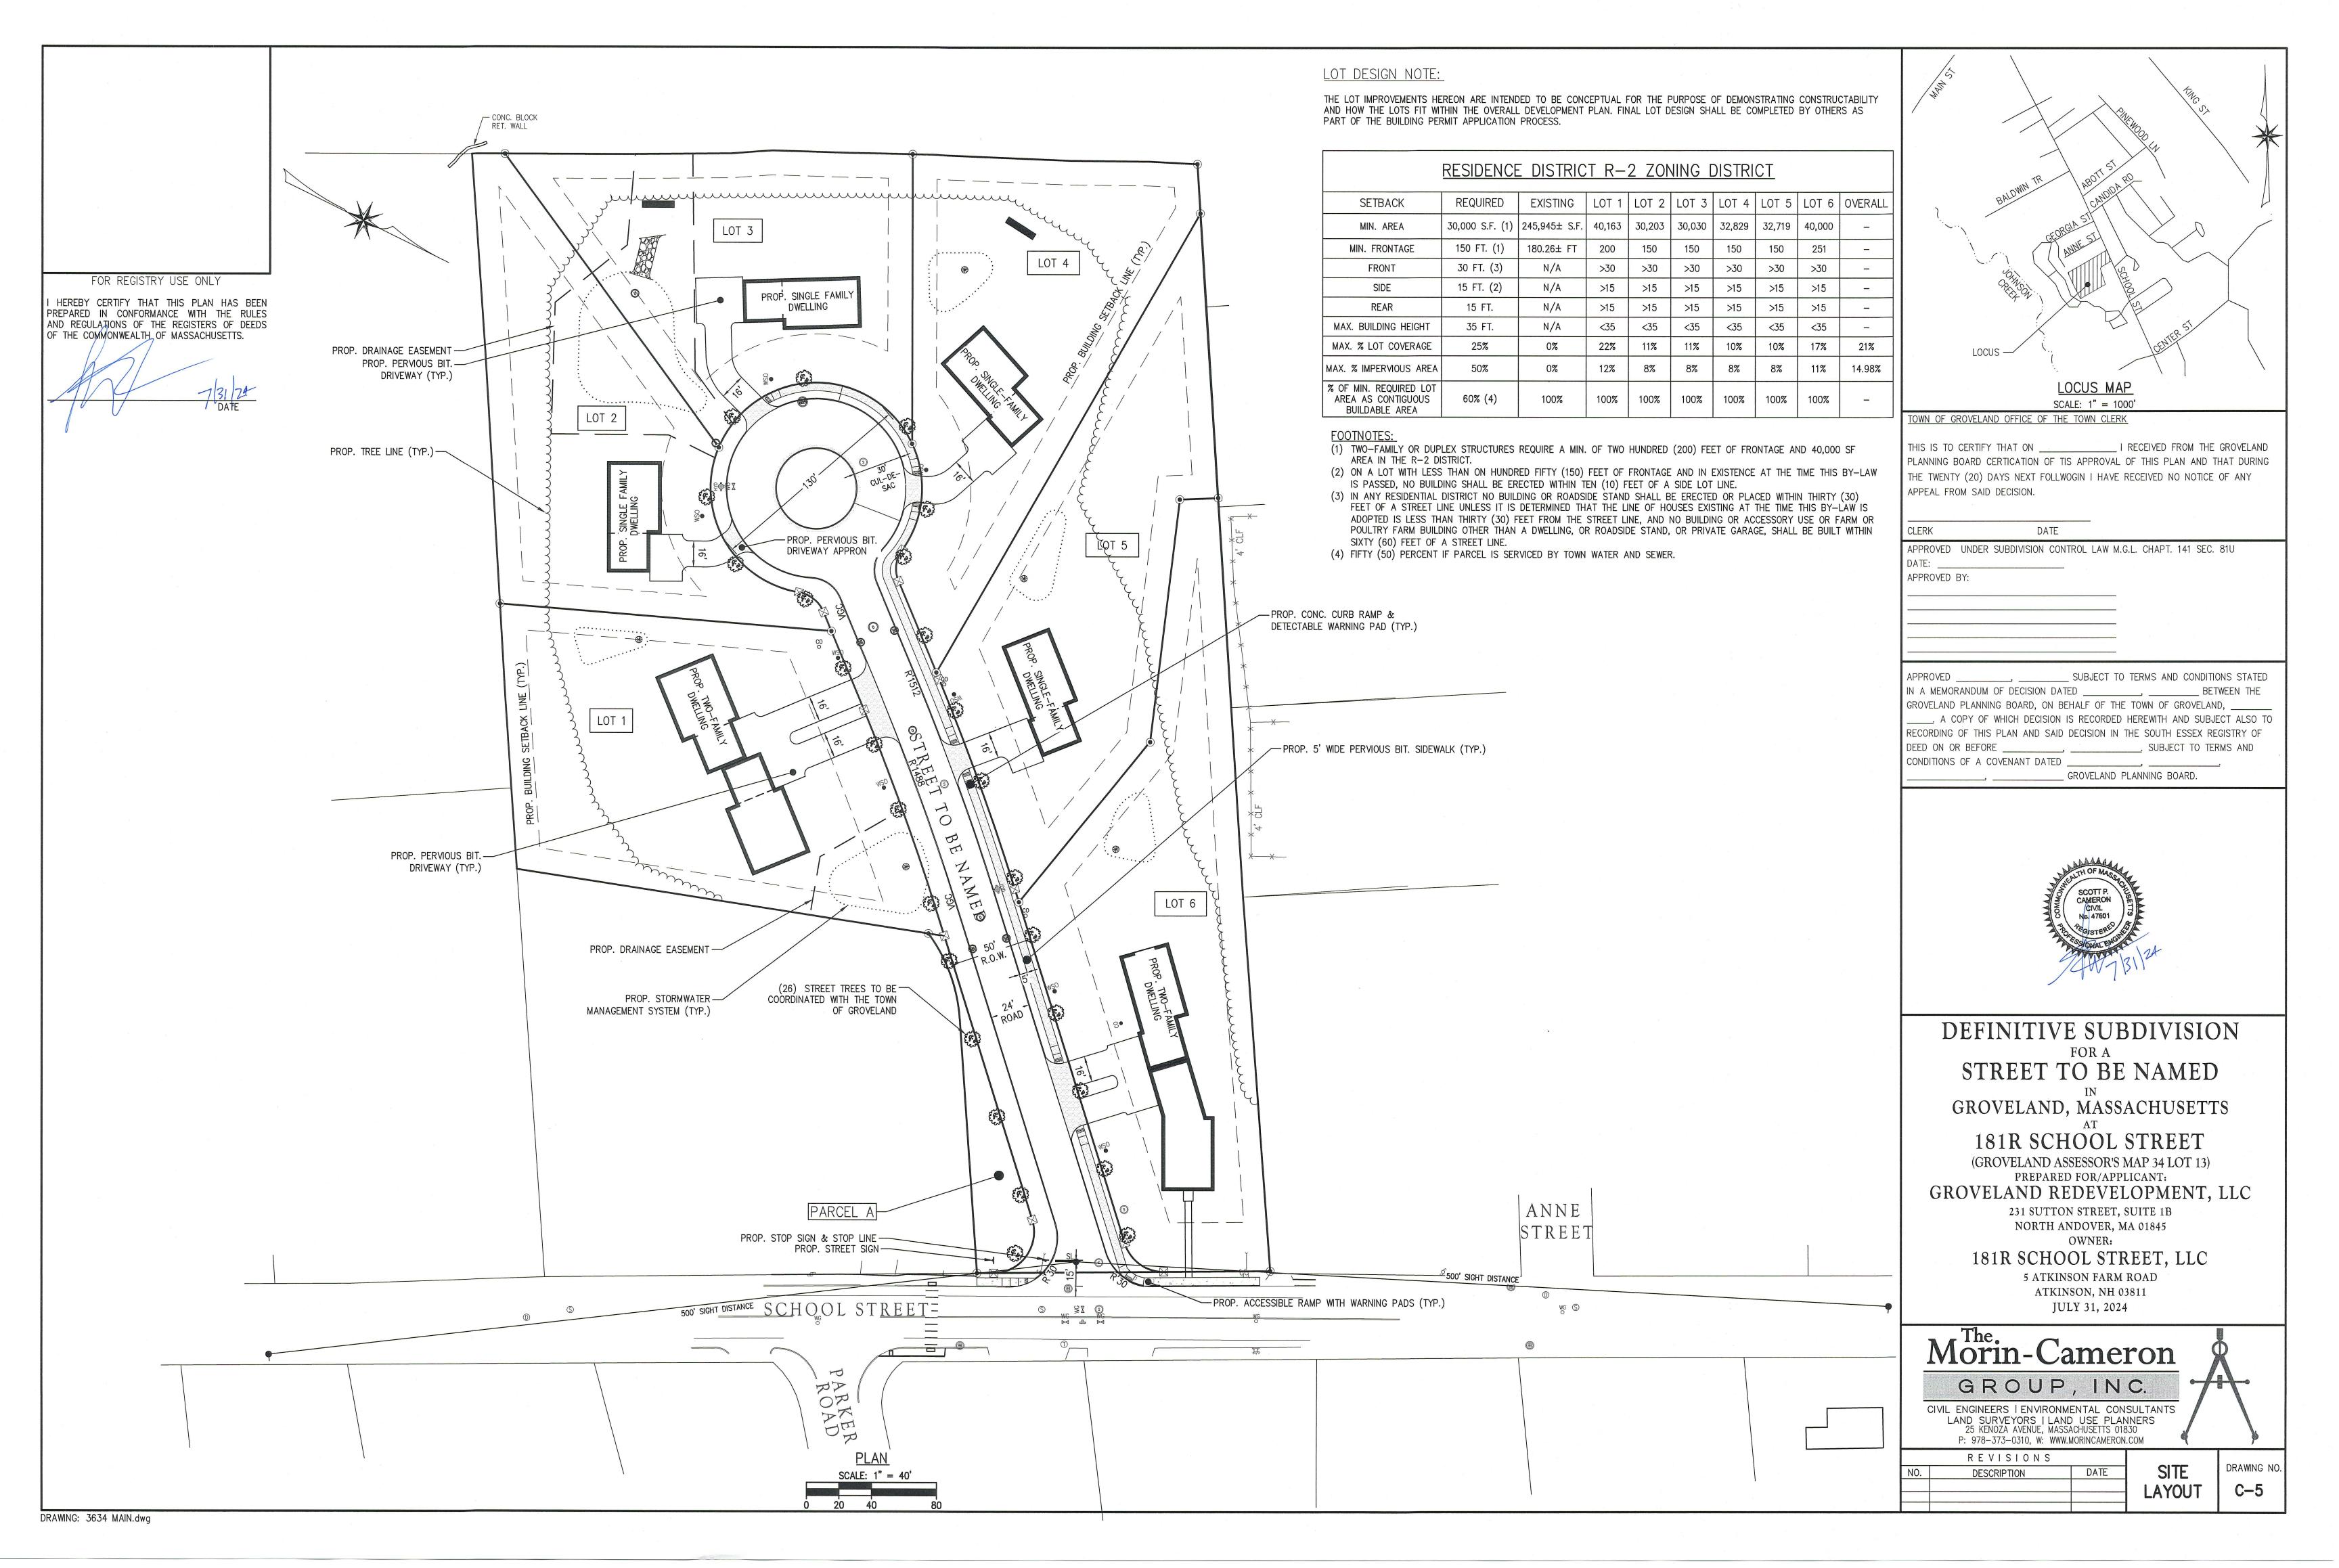


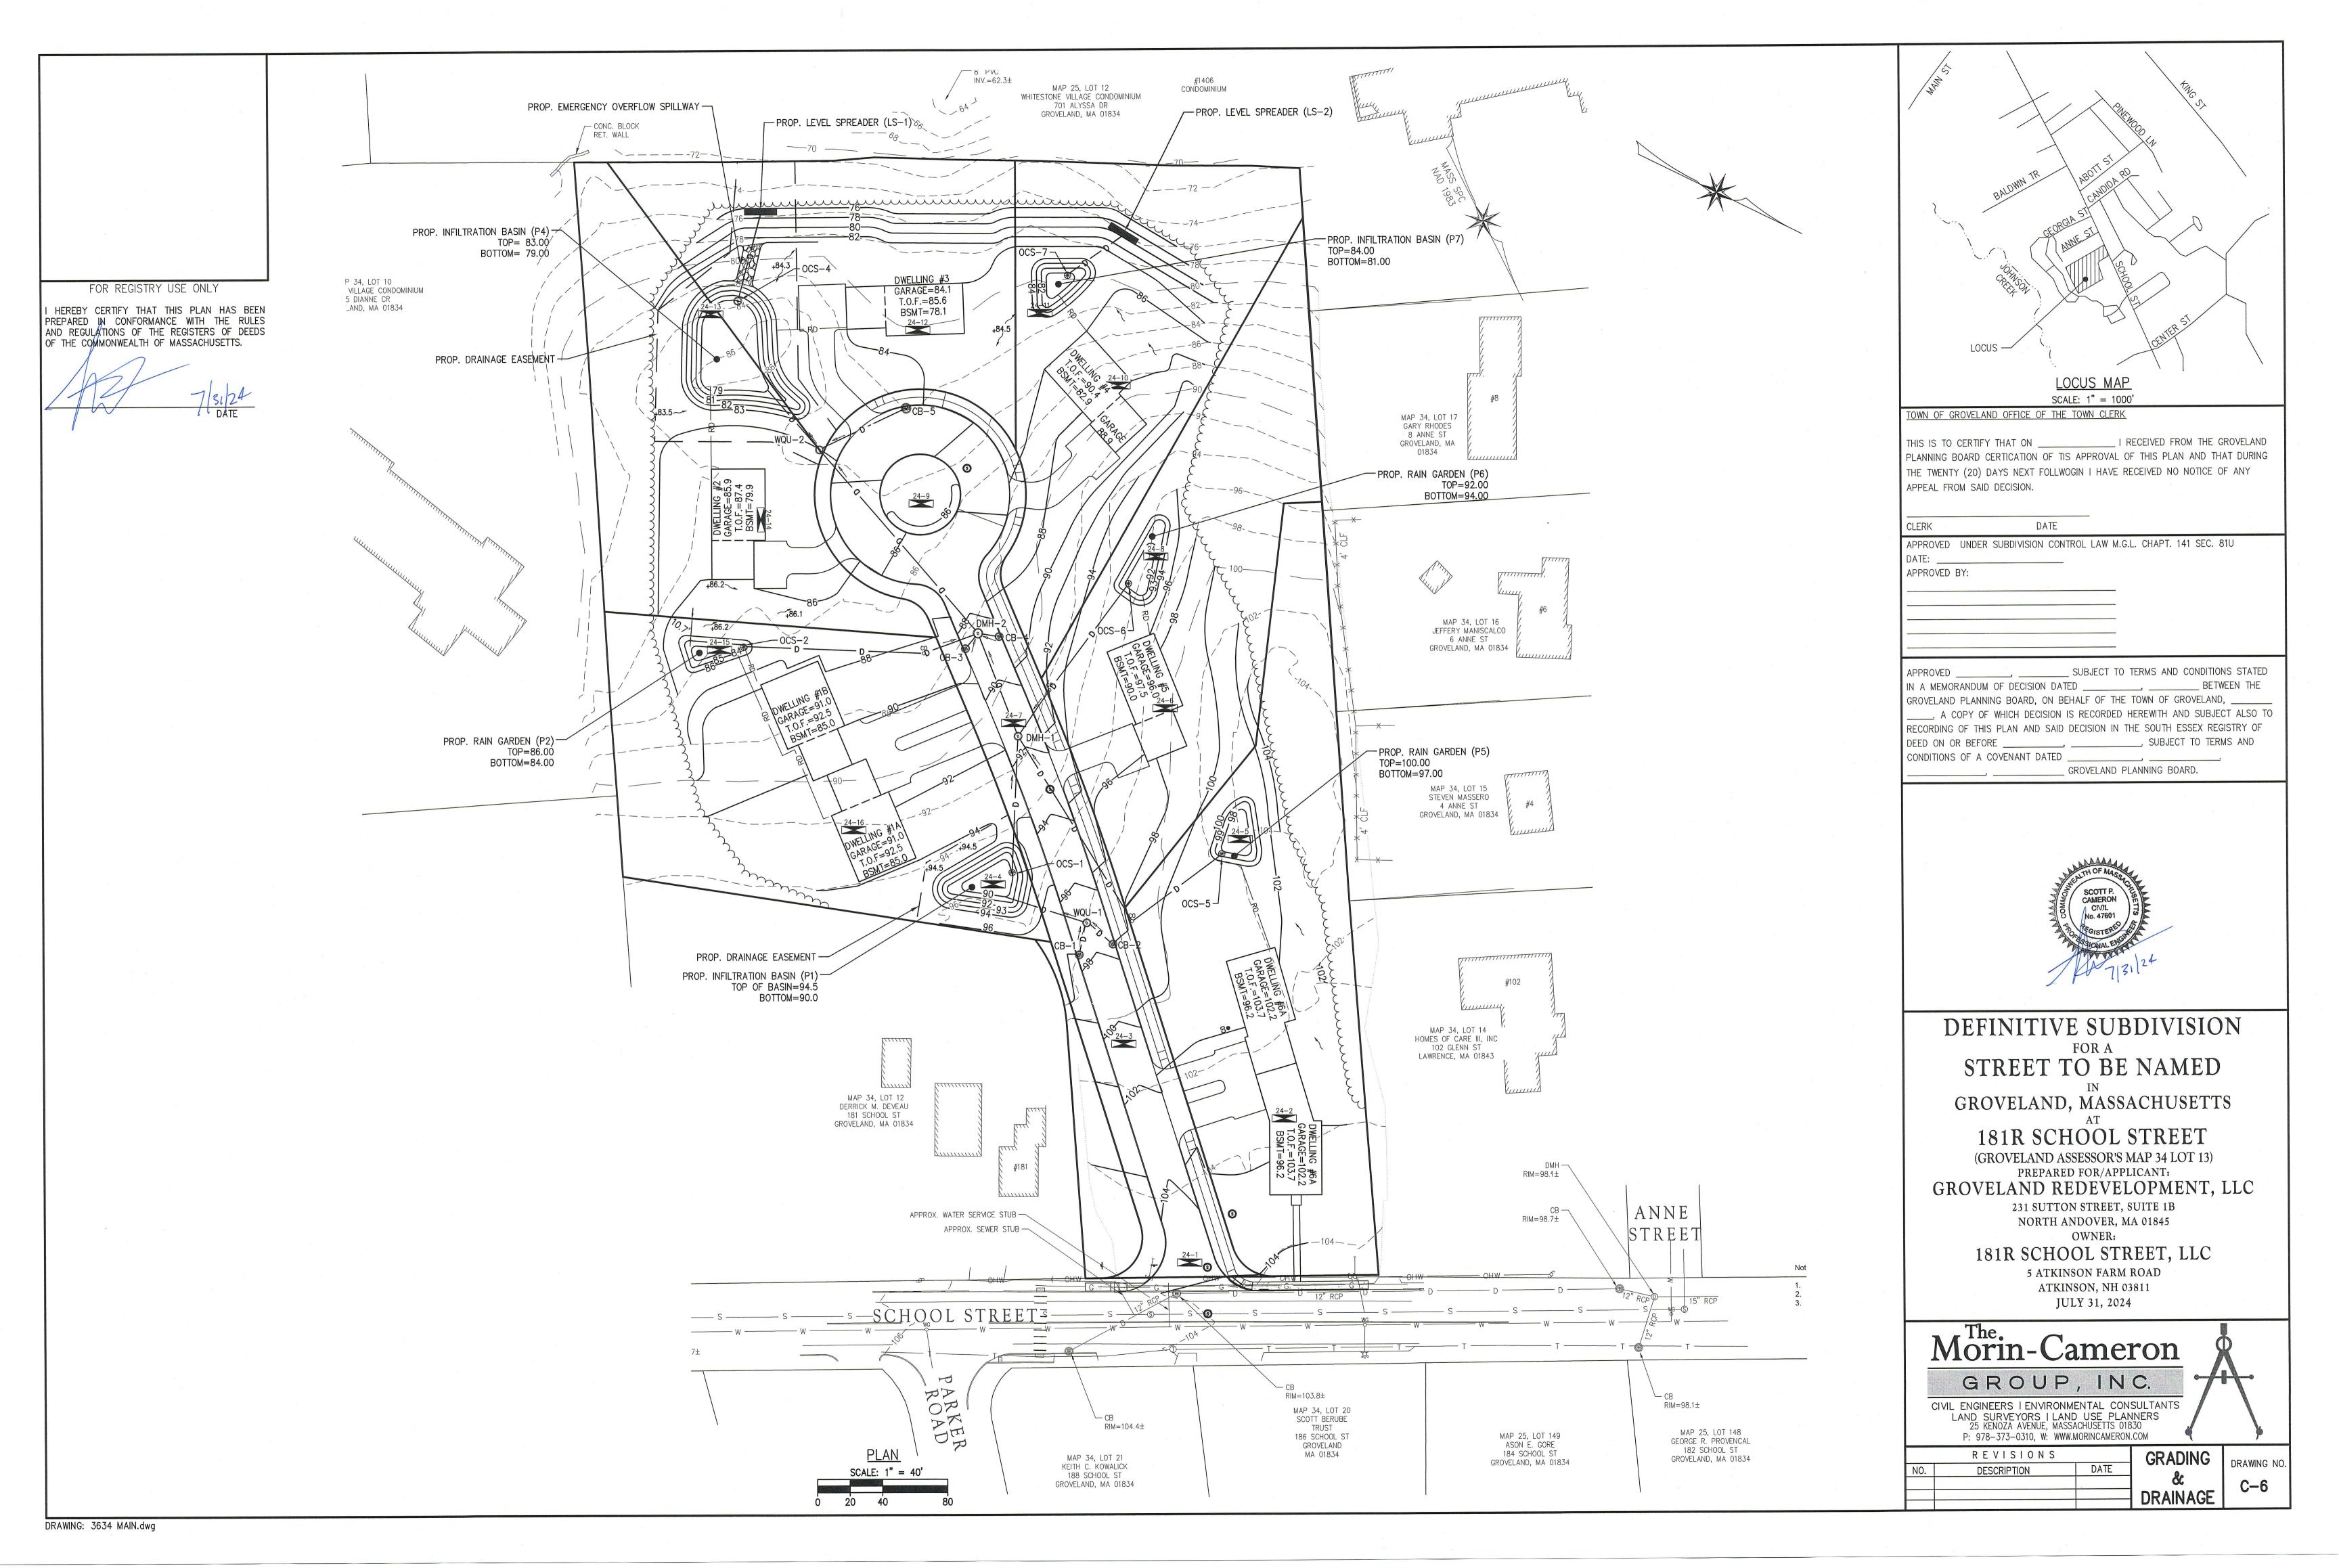


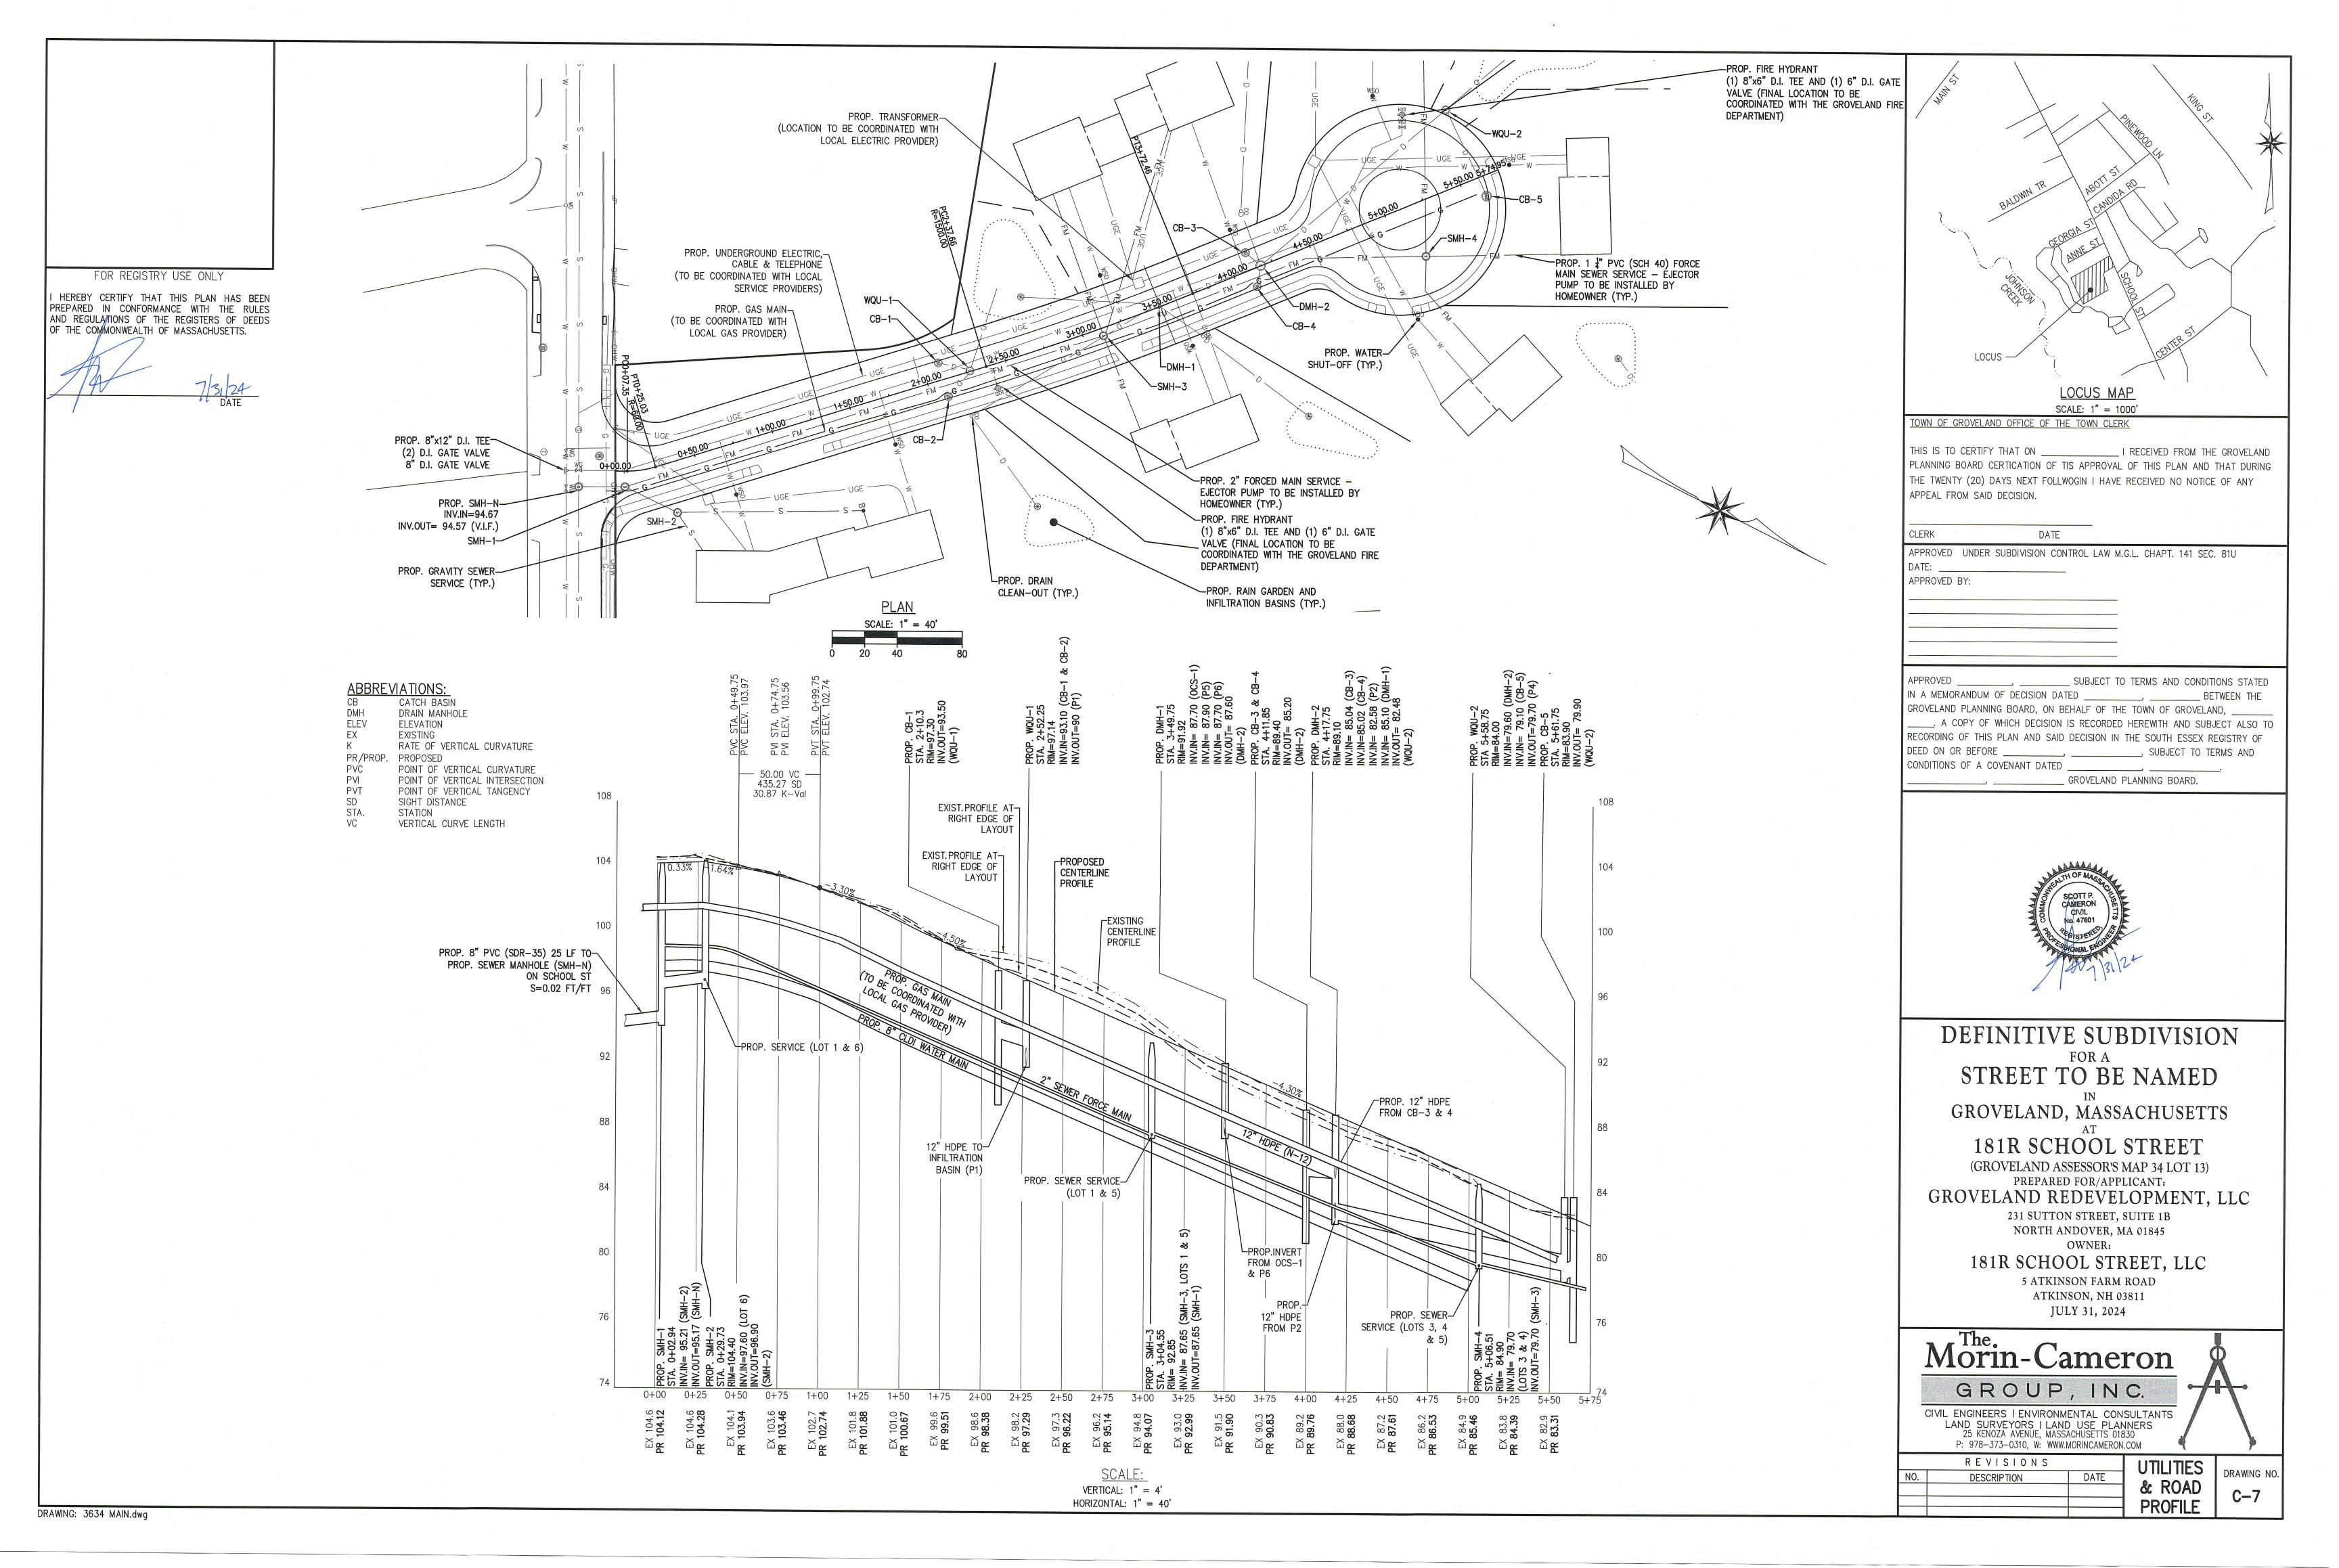

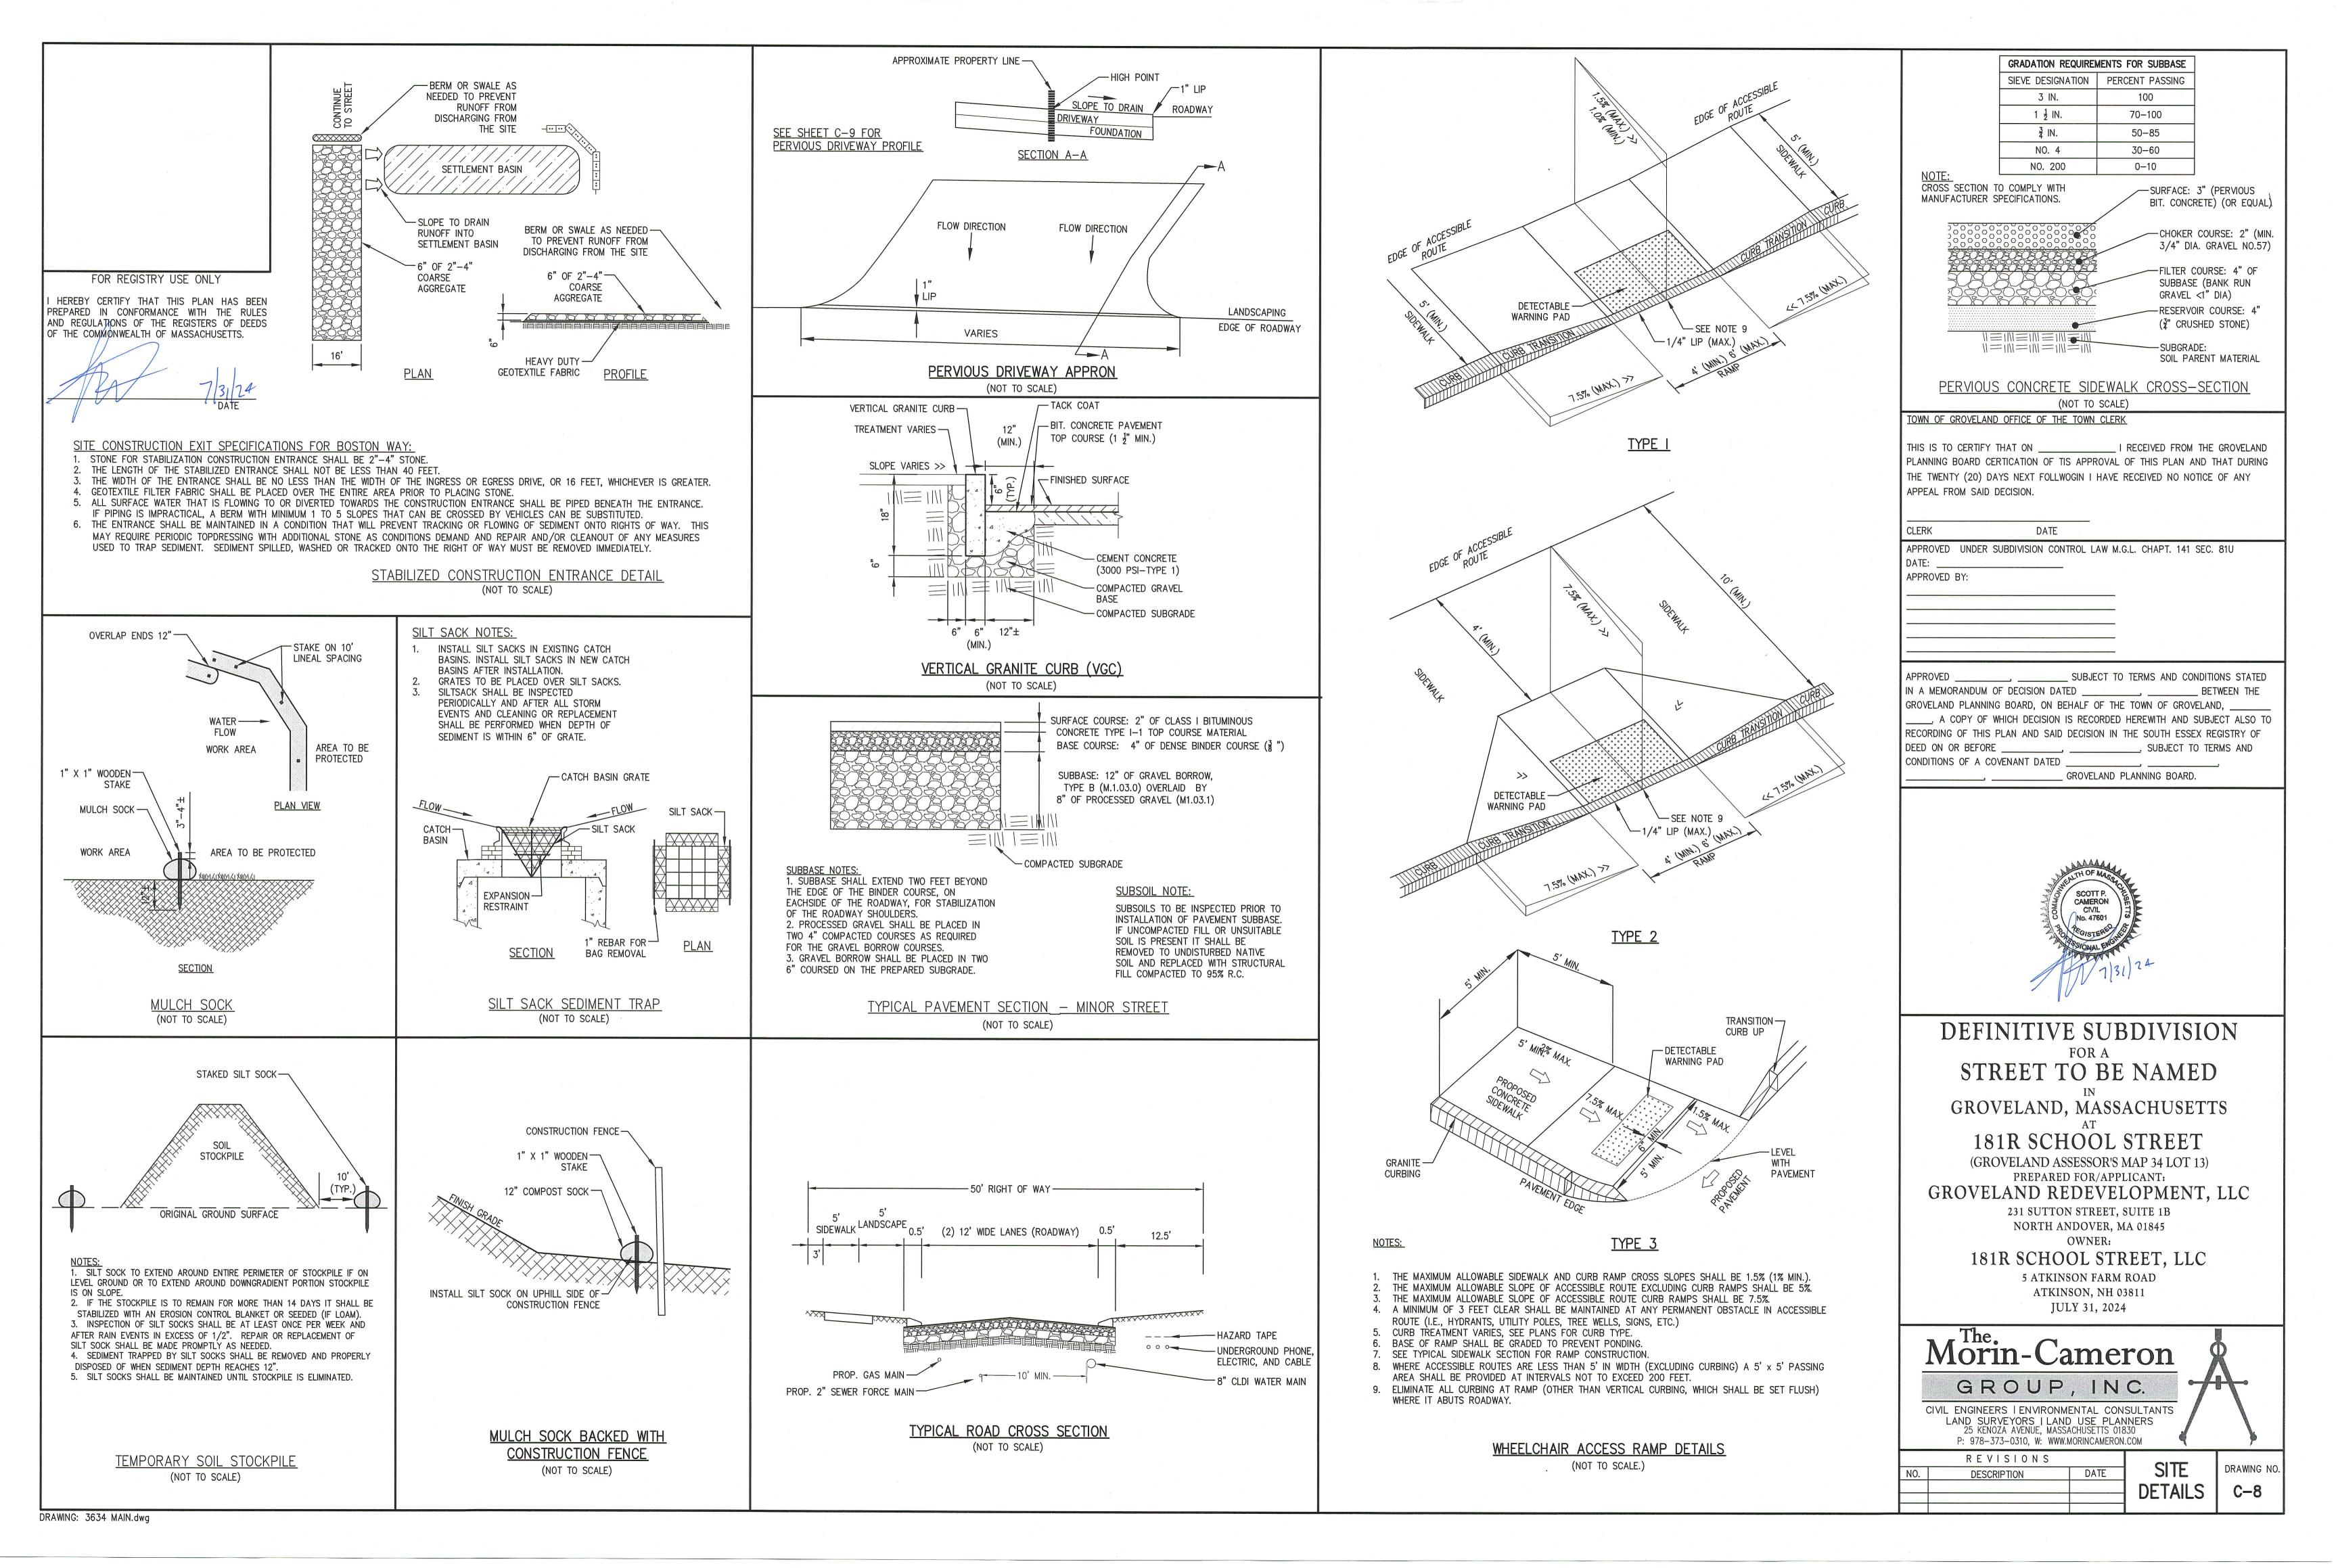

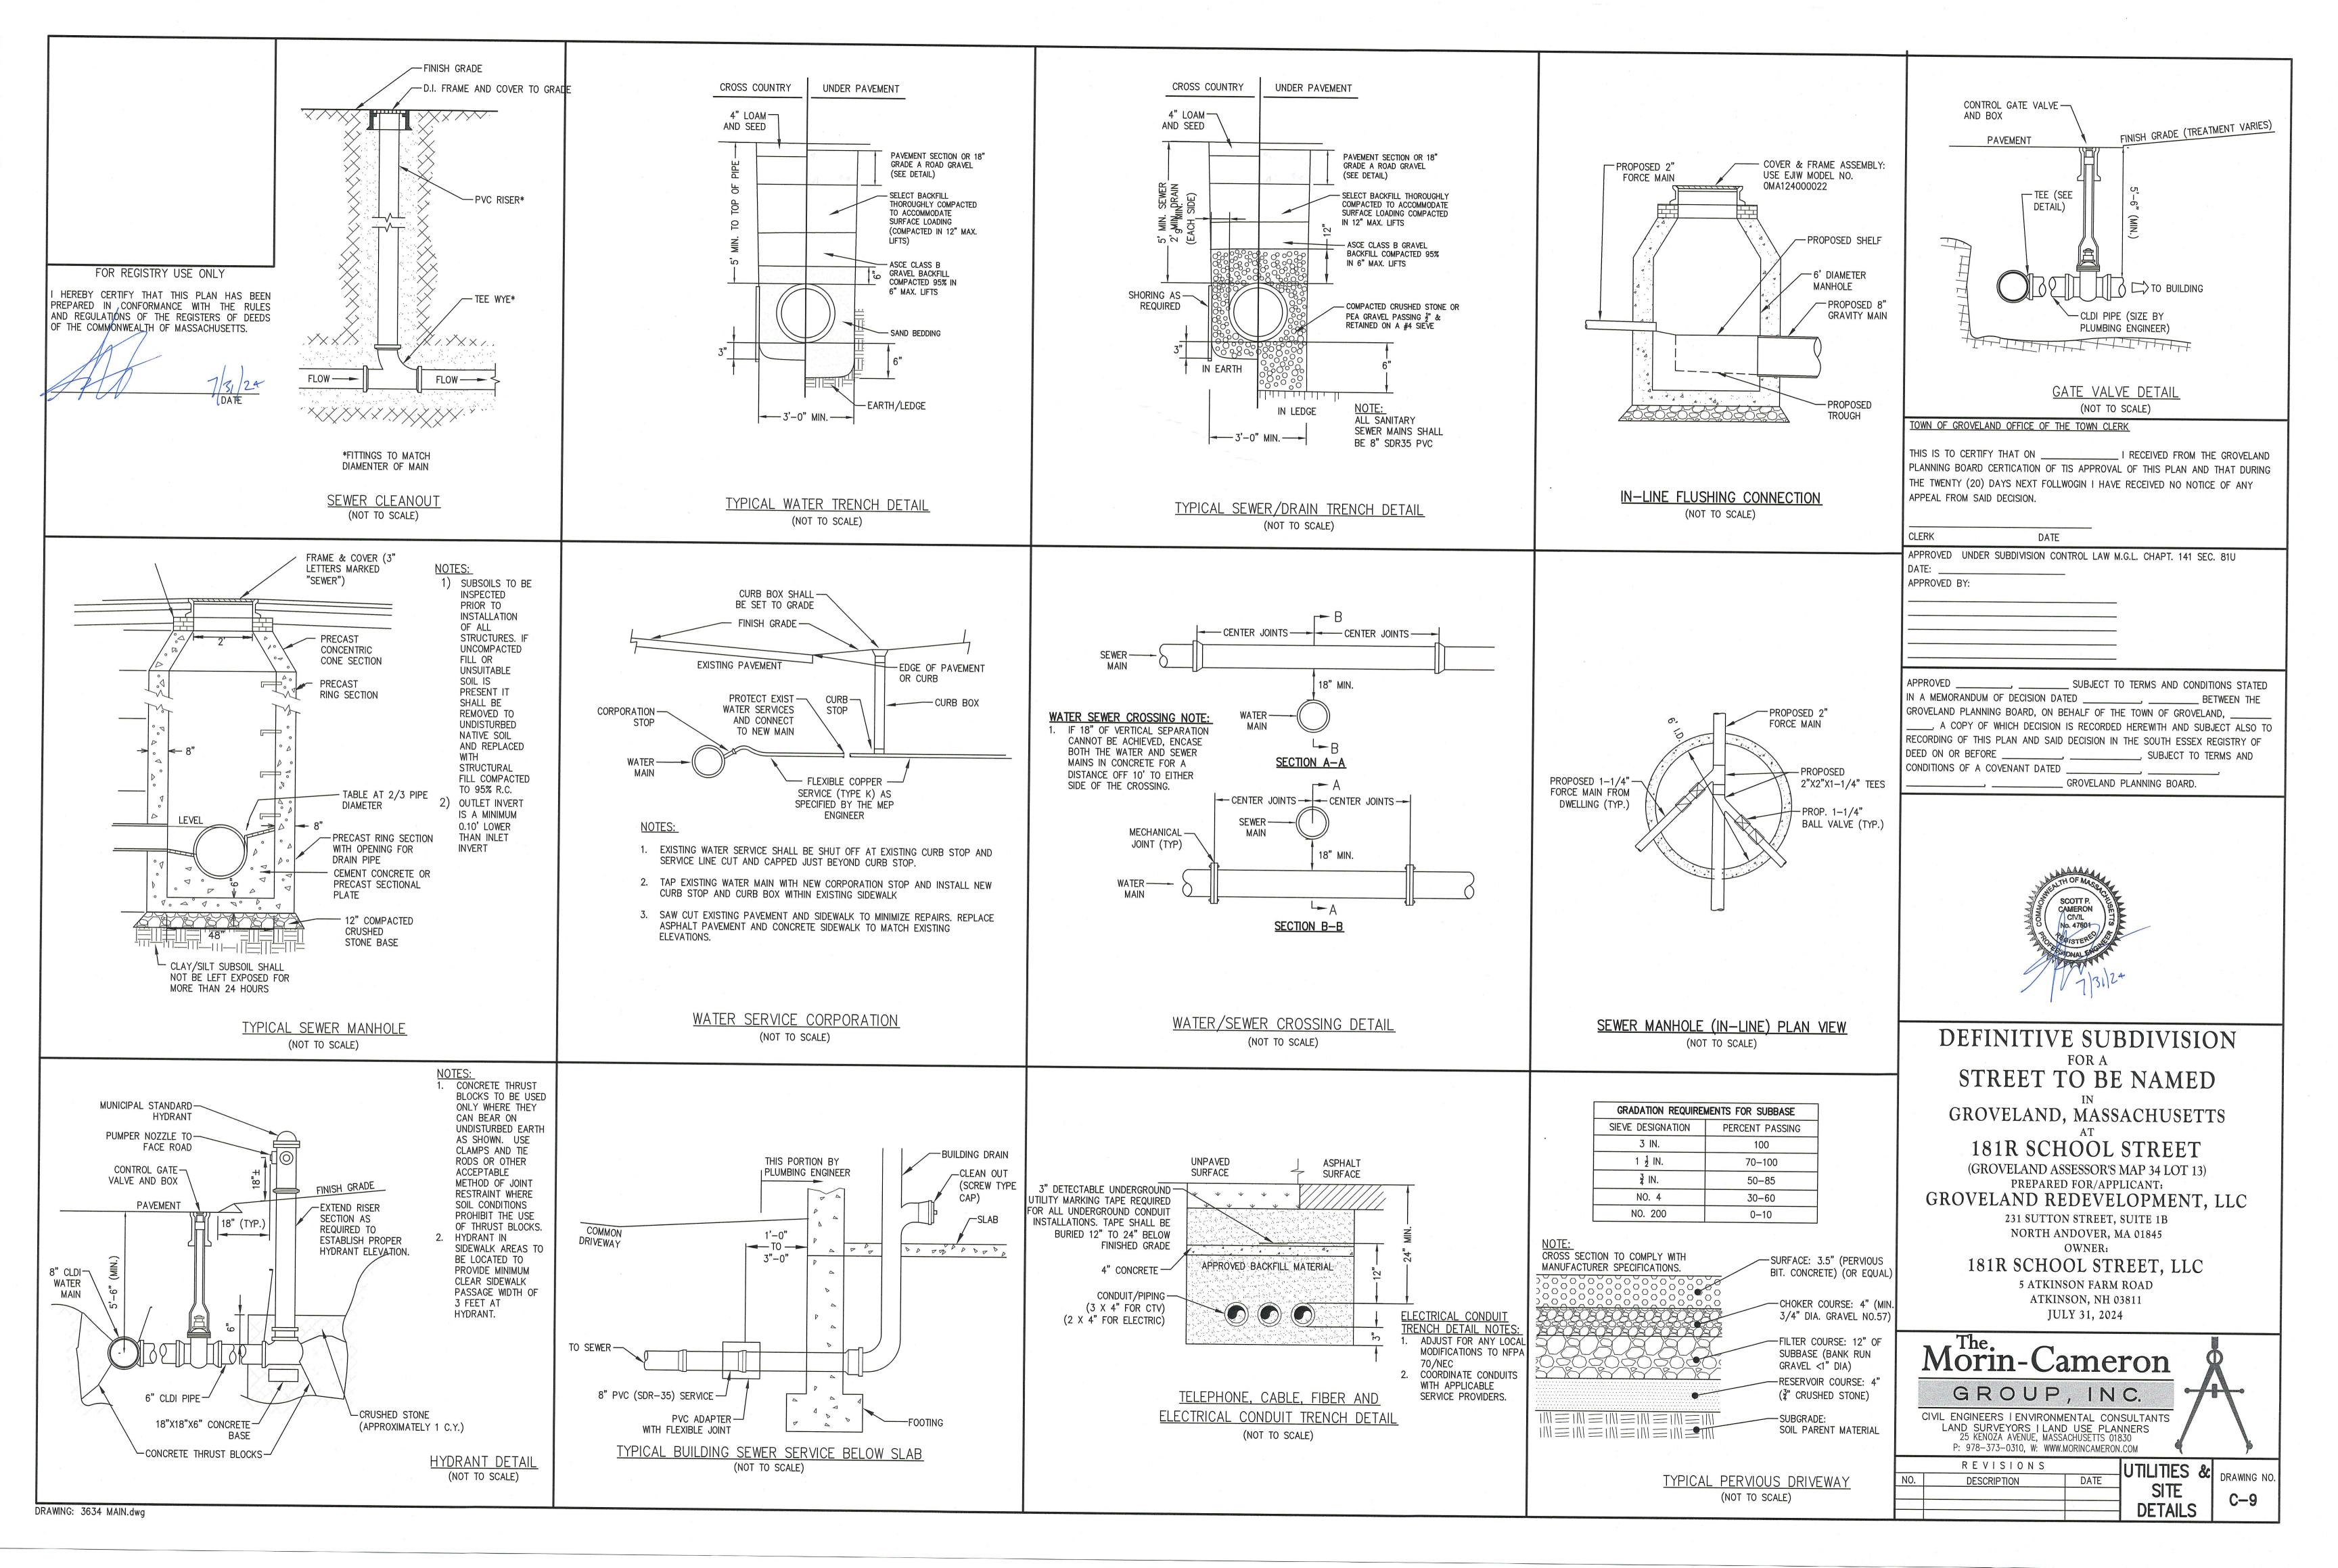

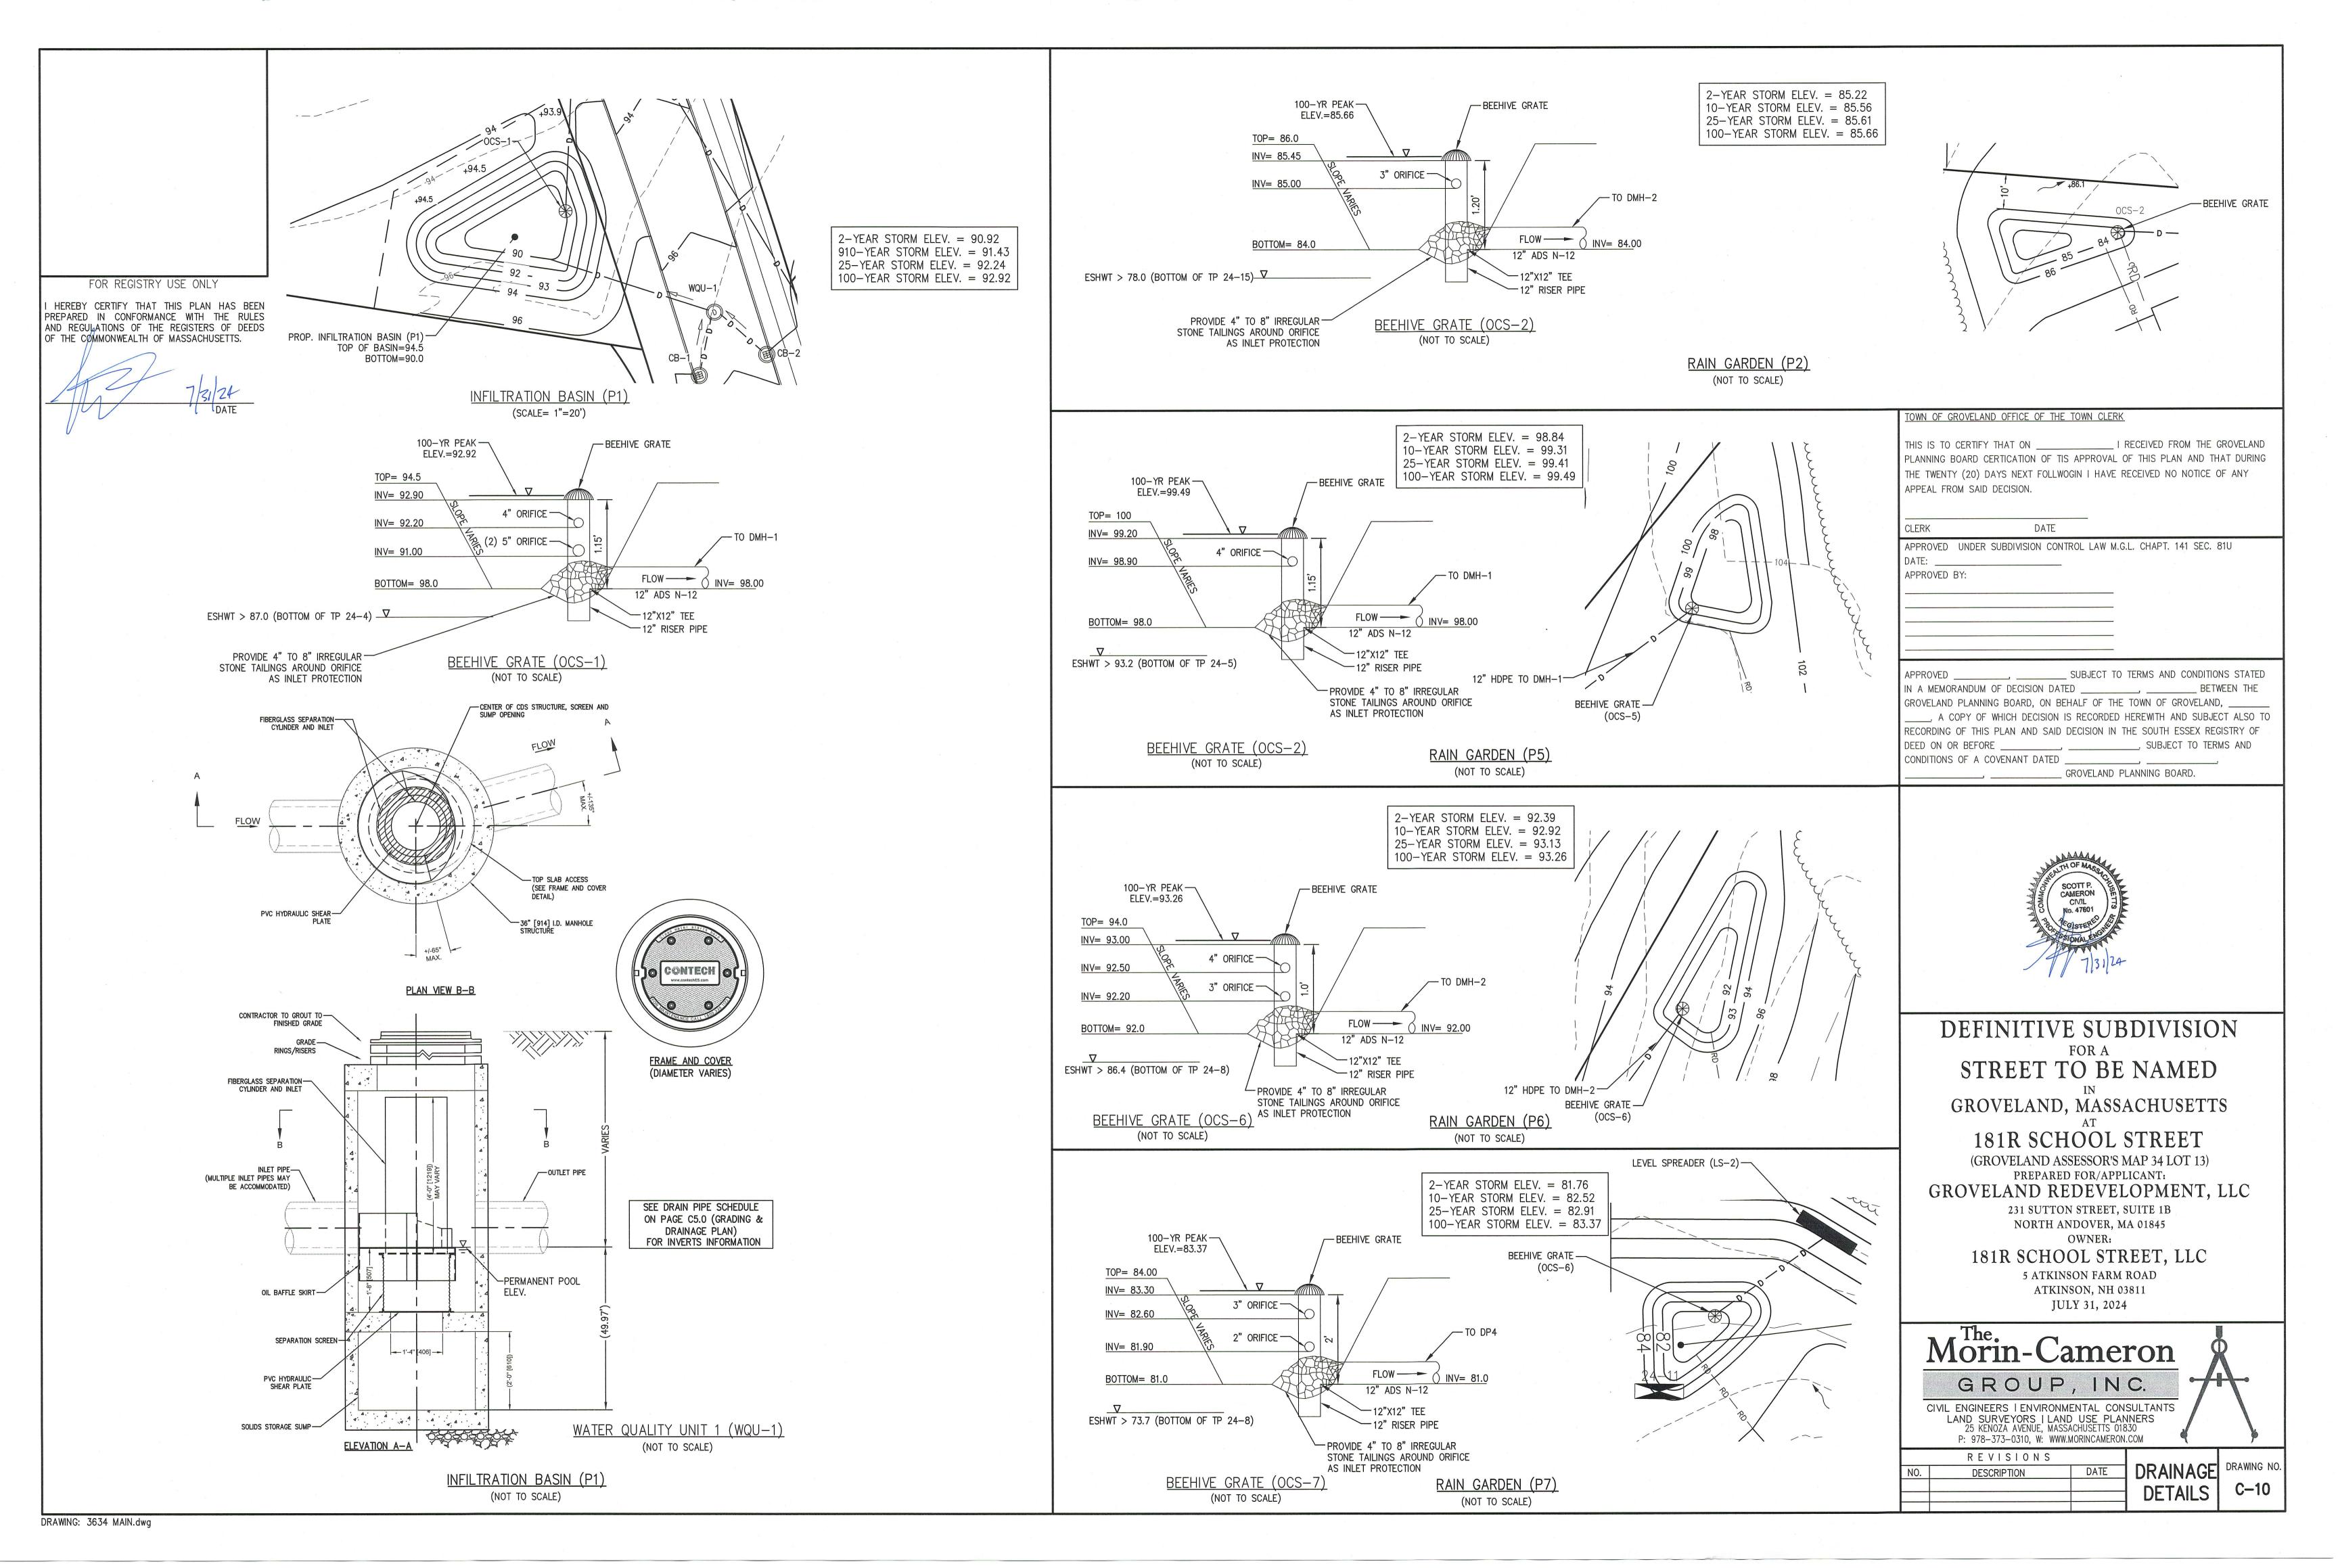

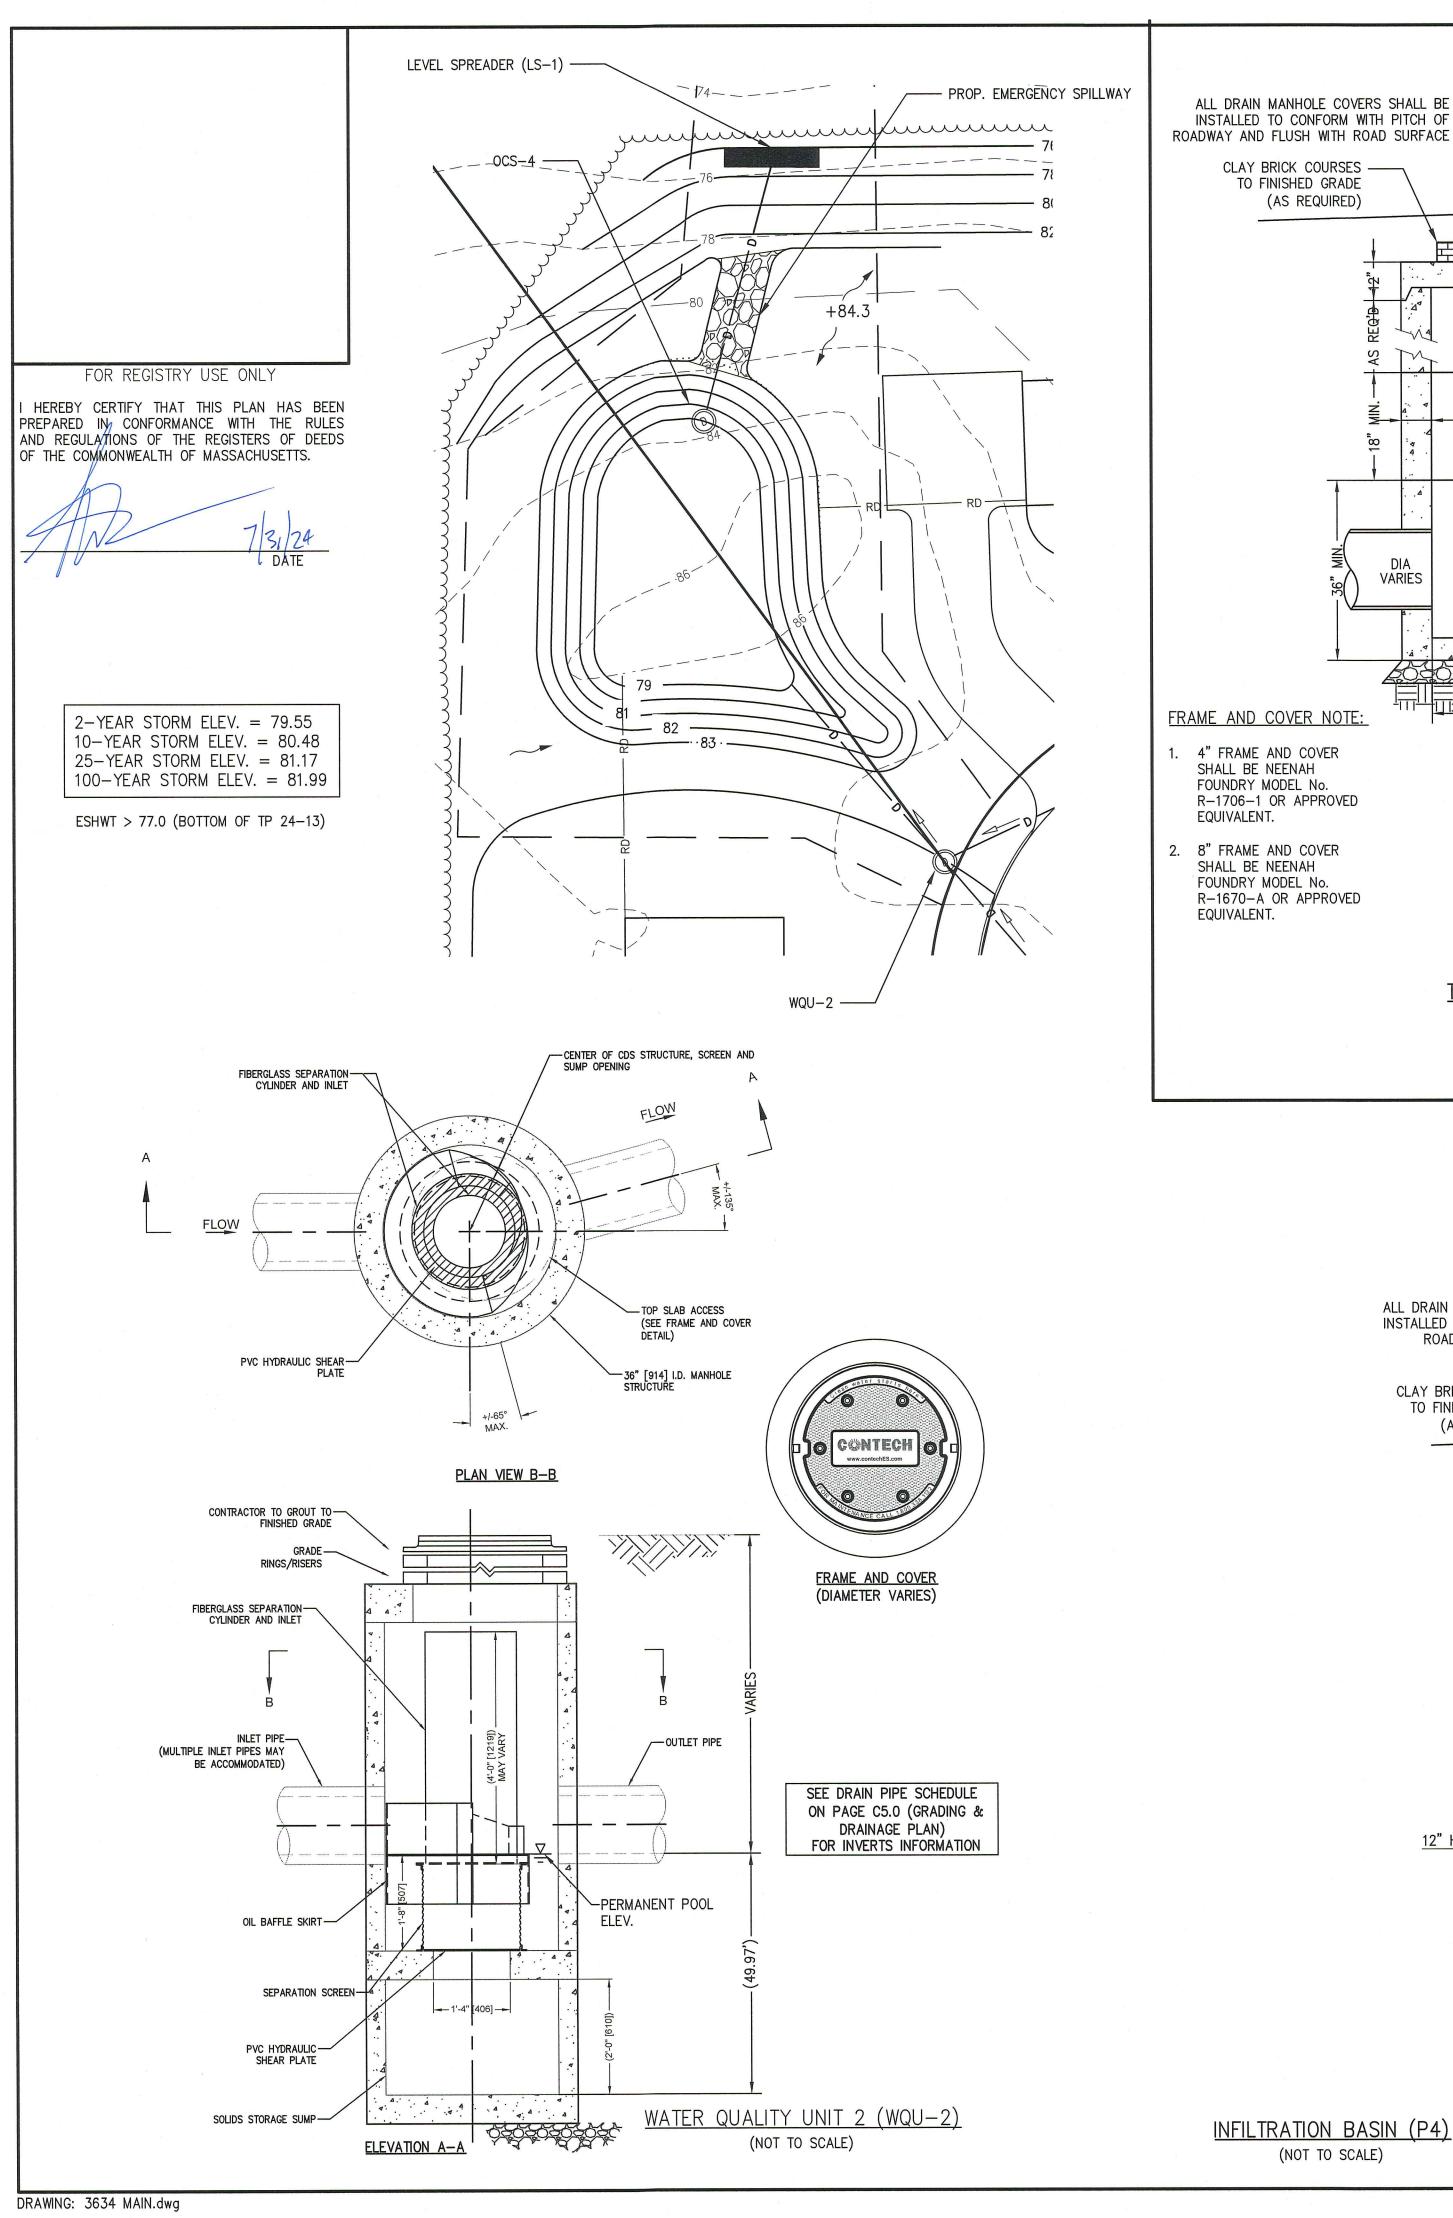

ALL DRAIN MANHOLE COVERS SHALL BE ---COVER & FRAME ASSEMBLY INSTALLED TO CONFORM WITH PITCH OF ROADWAY AND FLUSH WITH ROAD SURFACE CLAY BRICK COURSES ----TO FINISHED GRADE PROPOSED FINISH GRADE (AS REQUIRED) PRECAST FLAT TOP OR CONE SECTION PRECAST RING SECTION - PRECAST CONCRETE MANHOLE SHALL CONFORM TO ASTM SPEC. NO. C 478-82A **PRECAST** RING SECTION WITH OPENING **VARIES** FOR DRAIN PIPE 12" COMPACTED CRUSHED STONE BASE FRAME AND COVER NOTE: EXISTING CLAY/SILT SUBSOIL SHALL NOT BE LEFT EXPOSED FOR MORE THAN 24 HOURS R-1706-1 OR APPROVED SUBSOIL NOTE: SUBSOILS TO BE INSPECTED PRIOR TO INSTALLATION OF ALL 8" FRAME AND COVER STRUCTURES. IF UNCOMPACTED FILL OR UNSUITABLE SOIL IS PRESENT IT SHALL BE REMOVED TO UNDISTURBED NATIVE SOIL AND REPLACED WITH STRUCTURAL FILL COMPACTED TO 95% R.C. R-1670-A OR APPROVED

TYPICAL DRAIN MANHOLE

(NOT TO SCALE)

ALL DRAIN MANHOLE COVERS SHALL BE ----

ROADWAY AND FLUSH WITH ROAD

SURFACE

20000000000000

INSTALLED TO CONFORM WITH PITCH OF

CLAY BRICK COURSES — TO FINISHED GRADE

12" HDPE IN

(AS REQUIRED)

NOTE:

1. ECCENTRIC CONE SECTION MAY BE SUBSTITUTED

COVER & FRAME ASSEMBLY
FLOW
PRECAST FLAT TOP
PRECAST RING SECTION
WITH
OPENING FOR DRAIN
PIPE

8"
PRECAST RING
SECTION WITH
OPENING FOR DRAIN
PIPE

8"
PRECAST RING
SECTION WITH
OPENING FOR DRAIN
PIPE

8"

FOR MORE THAN 24 HOURS
FRAME AND COVER NO

SUBSOIL NOTE:

SUBSOILS TO BE INSPECTED PRIOR TO INSTALLATION OF ALL STRUCTURES. IF UNCOMPACTED FILL OR UNSUITABLE SOIL IS PRESENT IT SHALL BE REMOVED TO UNDISTURBED NATIVE SOIL AND REPLACED WITH STRUCTURAL FILL COMPACTED TO 95% R.C.

FRAME AND COVER NOTE:

4 4 4 4 4 4 4

EXISTING CLAY/SILT SUBSOIL

SHALL NOT BE LEFT EXPOSED

 3" FRAME AND COVER SHALL BE NEENAH FOUNDRY MODEL No. R-3560 OR APPROVED EQUIVALENT.

PRECAST SILT

STONE BASE

12" COMPACTED CRUSHED

2. 6" FRAME AND COVER SHALL BE NEENAH FOUNDRY MODEL No. R—3405 OR APPROVED EQUIVALENT.

TOP OF BAFFLE

12"W x 5"H ORIFICE

14"W x 5"H ORIFICE

8"W x 3"H ORIFICE

INV = 79.65

INV = 79.20

|NV| = 81.90

'[△] INV = 80.90

TYPICAL CATCH BASIN (NOT TO SCALE)

LEVEL SPREADER NOTES:


1. IT IS CRITICAL FOR THE CURB TO BE SET LEVEL ACROSS ITS ENTIRE LENGTH TO ENSURE PROPER LEVEL SPREADER FUNCTION.

2. MAXIMUM ALLOWABLE TOLERANCE FOR LEVELING CURB IS <0.25".

3. PRECAST CURB IS A SUITABLE SUBSTITUTE FOR GRANITE CURB.

4. CURB JOINTS SHALL BE MORTARED TO CREATE A SMOOTH TRANSITION BETWEEN SECTIONS. MAXIMUM SECTION LENGTHS SHALL BE USED TO MINIMIZE JOINTS.

5. ALL EXPOSED SOIL AREAS SHALL BE REINFORCEMENT WITH AN EROSION CONTROL BLANKET (JUTE MESH) OR EQUIVALENT. SEED SHALL BE APPLIED AT A RATE OF 4 LBS PER 1000 SF AND SHALL INCLUDE A MAJORITY OF PERENNIAL RYE FOR

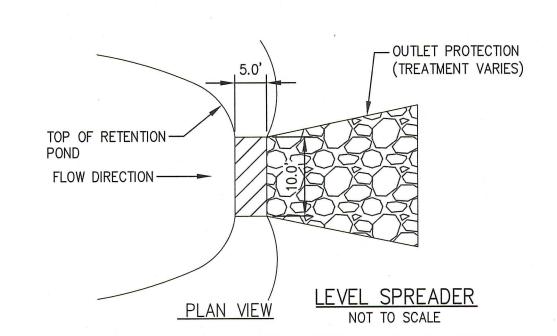

TOWN OF GROVELAND OFFICE OF THE TOWN CLERK

QUICK GERMINATION TIMES.

THIS IS TO CERTIFY THAT ON ______ I RECEIVED FROM THE GROVELAND PLANNING BOARD CERTICATION OF TIS APPROVAL OF THIS PLAN AND THAT DURING THE TWENTY (20) DAYS NEXT FOLLWOGIN I HAVE RECEIVED NO NOTICE OF ANY APPEAL FROM SAID DECISION.

APPROVED UNDER SUBDIVISION CONTROL LAW M.G.L. CHAPT. 141 SEC. 81U

DATE: _____
APPROVED BY: _____

_ GROVELAND PLANNING BOARD.

SCOTT P.
CAMERON
CIVIL
No. 47601
SGISTERE

DEFINITIVE SUBDIVISION
FOR A
STREET TO BE NAMED

GROVELAND, MASSACHUSETTS

181R SCHOOL STREET (GROVELAND ASSESSOR'S MAP 34 LOT 13)

PREPARED FOR/APPLICANT:
GROVELAND REDEVELOPMENT, LLC

231 SUTTON STREET, SUITE 1B NORTH ANDOVER, MA 01845

OWNER:
181R SCHOOL STREET, LLC

5 ATKINSON FARM ROAD ATKINSON, NH 03811 JULY 31, 2024

Morin-Cameron

GROUP, INC.

CIVIL ENGINEERS | ENVIRONMENTAL CONSULTANTS LAND SURVEYORS | LAND USE PLANNERS 25 KENOZA AVENUE, MASSACHUSETTS 01830 P: 978-373-0310, W: WWW.MORINCAMERON.COM

R E V I S I O N S

DESCRIPTION DATE

DRAINAGE DRAWING DETAILS C-11

NOTE: BAFFLE WALL TO BE SECURED TO PRECAST MANHOLE AND THE BOTTOM AND SIDES SHALL BE GROUTED WITH HYDRAULIC CEMENT.

OUTLET CONTROL STRUCTURE (OCS-4)

(NOT TO SCALE)

- COVER & FRAME ASSEMBLY:

MODEL NO. V1418/V1600-2

PRECAST FLAT TOP OR CONE SECTION

PRECAST CONCRETE

CONFORM TO ASTM

MANHOLE SHALL

PRECAST

RING SECTION

SPEC. NO. C 478-82A

- 6" BAFFLE WALL

PRECAST RING

SECTION WITH

OPENING FOR

12" HDPE OUT 6" BAFFLE WALL-

- 6" COMPACTED CRUSHED STONE BASE

DRAIN PIPE

USE EQUIVALENT TO EJIW

PROPOSED FINISH GRADE